



shire of Ashburton
reef to range

Business Plan

Onslow
Ocean View Caravan Park (Phase 3)
April 2022



Table of Contents

| | | |
|--------|--|---|
| 1. | Organisation Details..... | 3 |
| 2. | Executive Summary | 3 |
| 3. | Project Scope and Evaluation..... | 4 |
| 3.1. | PROJECT PURPOSE | 4 |
| 3.2. | PROJECT BACKGROUND..... | 4 |
| 3.3. | PROJECT DESCRIPTION..... | 4 |
| 3.3.1. | PROJECT APPROVALS | 5 |
| 3.3.2. | PROJECT DELIVERY | 5 |
| 3.4. | STAKEHOLDERS..... | 6 |
| 3.4.1. | KEY PROJECT STAKEHOLDERS | 6 |
| 3.4.2. | STAKEHOLDER ENGAGEMENT STATUS | 6 |
| 3.5. | ECONOMIC AND FINANCIAL ANALYSIS..... | 6 |
| 3.6. | FUNDING STRATEGY | 7 |
| 3.6.1. | TOTAL BUDGET AND FUNDING | 7 |
| 3.7. | PROJECT KEY MILESTONES, TIMEFRAME AND COST | 7 |
| 3.8. | RISK ANALYSIS | 7 |
| 3.9. | SUPPORTING DOCUMENTS | 9 |
| 4. | Signing Of Business Case | 9 |

1. Organisation Details

| | |
|--------------------------|--|
| Organisation | The Shire |
| Organisation Type | Local Government |
| Core Business | Provision of services to local communities and ratepayers |
| Project Name | Ocean View Caravan Park (Phase 3) |
| Contact | Chantelle McGurk |
| Position | Director Projects and Procurement |
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| Postal Address | PO Box 567, Tom Price WA 6751 |
| Email | chantelle.McGurk@ashburton.wa.gov.au |
| Website | www.ashburton.wa.gov.au |

2. Executive Summary

The Ocean View Caravan Park (Phase 3) project entails the design and construction of a third Phase of the successful Ocean View Caravan Park, to satisfy the ever-increasing demand for holiday accommodation in Onslow. The key project driver is to have the new facility open to cater for the anticipated surge in demand for accommodation for the Lunar Eclipse in April 2023. This is a unique opportunity to showcase Onslow as the hidden gem in the list of WA regional holiday destinations.

Lot 381 was acquired by the Shire in 2021 with the intent to further expand holiday accommodation options in Onslow. Following completion of a Masterplan including Chalets and Caravan sites, the Shire now intends to construct the first Phase of caravan sites and amenities as shown on the attached architects' drawings. The Lot of approx. 2.4ha is held by under Freehold Title and located 150m NW of the existing Ocean View Caravan Park. Access to this Lot will be via a gravel road, constructed over Lot 3504. The Management Orders for this portion of Land are anticipated imminently as they have been approved in principle for issue to the Shire.

Concept design and costing have been completed for the development, showing a total expenditure of \$8.6 mil over financial years 21/22 and 22/23. A 10 year profit and loss forecast has been prepared by the Shire and attached to this document. Due to the increased income helping to offset various fixed overheads on the current facility, the new combined facility moves into a profitable position in 2024. Onslow will also experience various other economic benefits through the increased capacity and seasonal tourism.

An assessment of the submitted Development Application is currently underway, after which consultant procurement and detailed design can commence. The construction Works will be tendered on approval of the Shire FY 22/23 budget and works are anticipated to start on site by October 2022 latest – to achieve practical completion by the end of March 2023.

3. Project Scope and Evaluation

3.1. Project Purpose

The purpose of the Ocean View Caravan Park Phase 3 extension is:

1. To develop the existing caravan overflow facility into a third phase of the successful existing facility;
2. Promote Onslow as a tourist destination and satisfy the increased demand of for regional holiday accommodation;
3. Generate additional seasonal income to support the businesses and residents of Onslow.

3.2. Project Background

Following the success of the Phase 2 upgrade to the existing Ocean View Caravan Park, the Shire investigated the masterplan option of developing Lot 381 into a mixture of furnished chalets and caravan sites. Considering the large capital expenditure, it was decided to install 105 caravan sites and three Chalets as a first stage of the development. The QS cost estimate for these works was calculated at \$11 mil. Copies of the Architects initial concept layout and the associated QS cost breakdown can be found under attachments 5 & 6 to this document.

Following a value engineering exercise which included the omission of the chalets and managers office/laundry, the revised scope of works allows for 104 caravan sites resulting in an overall cost estimate of \$8.6mil. Copies of the Architects DA drawings and the associated QS cost breakdown can be found under attachments 2 & 3 to this document.

3.3. Project Description

The current scope of works includes the design and construction of a new Caravan Park with similar appearance and finishes to the recently complete Ocean View Caravan Park Phase 2 upgrade. The new Phase 3 facility will include the following components:

Ocean View Caravan Park (Phase 3)



1. All necessary civil Works including, drainage, stormwater management, retaining walls, kerbing, road finishes, etc to create road access and 104 new caravan sites;
2. A new gravel access road over Lot 3504;
3. All power, lighting and hydraulic services, including CCTV, a new cable gate and dump point;
4. Two new full amenity blocks with UAT facilities in accordance with the Caravan Parks Act;
5. An electronic check-in kiosk, linked back to the main park reception;
6. New BBQ area, playground equipment, fish cleaning station, boat storage and gas bullets;
7. Appropriate landscaping.

3.3.1. Project Approvals

Project Approvals

| Approval/Permit | Description |
|-------------------|---|
| Planning | An application for Development Approval was submitted 25/03/22. The outcome of this application is under discussion and anticipated before the end of April 2022. Pending issue of the Management Orders for Lot 3504, a second DA may be required for an extension to Second Ave to create the new temporary access road to the proposed development. |
| Funding | Pending Council assessment of this Business Case |
| Tender Award | Appointment of the successful Tenderer with Council approval after a formal construct-only tender process |
| Building Permit | Building Approvals by the successful Tenderer |
| Occupation Permit | Following Practical Completion |

3.3.2. Project Delivery

The Shire has extensive experience in managing projects of similar size or larger over many years. Despite many challenges in completing the Phase 2 upgrade to the existing Park, these works were opened in time for the annual tourist season.

The Shire currently contracts a dedicated project manager (A4 Projects) who have provided a strong project delivery record for the Shire, over the last 8 years.

The new facility will be operated by the existing Ocean View Caravan Park management team with a proven track record of 5 years on the existing facility.

Concept designs and costing have been completed and are attached to this document. A Development Application has been submitted and is under consideration by the shire Planning department.

As with the Ocean View Phase 2 upgrade project, the works will be designed by specialist Consultants and tendered on a Construct only basis.

Following Tender award, the Shires project manager will complete all necessary site meetings and contract administration to bring the Works to practical completion ahead of the Lunar Eclipse anticipated in April 2023.

3.4. Stakeholders

3.4.1. Key Project Stakeholders

Current stakeholders have been identified as:

- The Shire of Ashburton (various departments)
- Ocean View Caravan Park
- Department of Lands, Planning & Heritage (DPLH)
- Buurabalayji Thalanyji Aboriginal Corporation (BTAC)
- Water Corporation
- Horizon Power

3.4.2. Stakeholder Engagement Status

The Shire has engaged with the Utility Providers over the last 3 months and await quotations for the required utility headworks

Engagement with DPLH commenced at the beginning of the year and issue of Management Orders for Lot 3504 (in favour of the Shire), are anticipated imminently.

Feedback from the Operators of the current Ocean View Caravan Park has been incorporated into the concept design for the proposed new phase.

The Shire of Ashburton have presented this freehold land development project to BTAC as part of the regular engagement process. BTAC have expressed their verbal support for the development, with a formal letter of support anticipated shortly.

3.5. Economic and Financial Analysis

The Shire has undertaken an internal evaluation of the economic impacts of the proposed project. This is based on the current accounts on the existing facility, with a projection of the anticipated income and costs for the expanded facility. Various benefits are derived through the improved economies of scale to help off-set some of the larger fixed overheads. A copy of this analysis is attached to this document, with a summary as follows:

| Ocean View Caravan Park | 2021 | 2022 | 2022 | 2023 | 2024 | 2025 | 2026 | 2027 | 2028 | 2029 | 2030 | 2031 | 2032 |
|-------------------------|-----------|----------|---------|------|---------|---------|---------|---------|---------|---------|---------|---------|---------|
| Net Profit / (Loss) | (289,400) | (42,800) | (7,800) | 0 | 155,000 | 149,200 | 143,400 | 137,400 | 131,200 | 124,800 | 117,900 | 110,800 | 103,500 |

It should be noted that this proposed project is carrying a cost of over \$350,000 to create the temporary extension to Second Avenue. This road will also benefit the future anticipated projects in the area – Memorial Park, Onslow Conference Centre, Onslow Jetty and further development in this



area. The additional economic benefits, and positive social and tourism returns to the Town of Onslow are not accounted for in this assessment.

3.6. Funding Strategy

3.6.1. Total Budget and Funding

The provisional budget for the project is \$8,6 mil as shown in the breakdown below. The project budget has been prepared using the attached Architects drawings, and a cost estimate prepared by BSM Quantity Surveyors (also attached). The Estimate is based on the costs associated with upgrading the second phase of the existing Park in 2021, with an allowance for price escalation in the current market. A pre-tender estimate will be prepared following completion of the detailed design.

Project Budget

| Item of Expenditure | Budget | Source of Fund | Funding Status |
|---------------------|--------------|-----------------------|----------------|
| Planning & Design | 350,000 | Shire | Yes |
| Services Headworks | 500,000 | Shire | No |
| Construction | 7,100,000 | Shire / Loan | No |
| Contingency | 700,000 | Shire / Loan | No |
| TOTAL | \$ 8,650,000 | FY 2021/22 2022/23 | |

3.7. Project Key Milestones, Timeframe and Cost

The project critical path is driven by the delivery of the facility prior to the anticipated Lunar Eclipse on 20 March 2023. The project team has identified a number of key milestones, along with the expected date of their achievement, for the project. A more detailed timeline will be developed on completion of the project plan, following approval of this Business Case.

Project Milestones, Completion Dates and Cost

| Main Activities / Milestone | Milestone Completion Date | Anticipated Activity Cost |
|---|---------------------------|---------------------------|
| Concept Design and Development Application approval | April 2022 | \$150,000 |
| Detailed design | July 2022 | \$175,000 |
| Procurement | October 2022 | \$25,000 |
| Construction and contingency | March 2023 | \$8,300,000 |

3.8. Risk Analysis

An initial risk analysis has been completed for the project to identify and evaluate the effect of uncertainty on objectives and deliverables. A summary of the risks assessed is shown in the table below.

Risk Analysis Register Summary

| ID | Potential Risk | Likelihood | Consequence | Risk Rating | Mitigation Measures |
|----|---|---|---|-------------|---|
| 1 | Inability to secure funding for the project | The project fails to compete with competing projects for funding | Funding is not approved, inadequate or significantly delayed | HIGH | High level of preliminary design and costing, matched with known operational costs allows a clear understanding of the economic benefits. |
| 2 | Delays in planning approvals | The proposed development is incompatible with current planning objects | Delays to the commencement of the project | MEDIUM | Shire Executive in close liaison with Planning Authority |
| 3 | Construction Issue/s | New risks are uncovered during detailed design or construction | Delays to the completion of the project and/or requirement for additional works | LOW | Project is based on a recent similar development; A geotechnical investigation has been completed; Construction will be managed by experienced Shire and Consultants. |
| 4 | Cyclonic weather | Construction Works need to take place during an off-peak tourist season, cyclone season | Delays to the completion of the project and/or requirement for additional works | MEDIUM | Inherent risk with Onslow's geographic location. Mitigated through Contractors appropriate safety management strategies |
| 5 | Ongoing sustainability of the facility | Lower than expected cash flow for the project | The project is not well maintained | TOLERABLE | The risk is mitigated on a partial cost recovery basis through in-house services with some specialist functions contracted out. |
| 6 | Decrease in utilisation of service | Lower than expected utilisation of the facility | The operator fails to be financially viable | TOLERABLE | Expansion of this facility is part of an overall marketing |



| ID | Potential Risk | Likelihood | Consequence | Risk Rating | Mitigation Measures |
|----|----------------|------------|-------------|-------------|------------------------------------|
| | | | | | strategy for Onslow and the region |

The Shire is responsible for risk management for the project delivery. This process is guided by a risk register to enable the ongoing review and management of the identified risks.

3.9. Supporting Documents

The following documents have informed the development of the business case and are attached to this document.

- ATT 1: Lot 381 Certificate of Title
- ATT 2: OVCP3 Architects DA submission Drawings
- ATT 3: OVCP3 Stage 1 Construction Cost Estimate (BSM)
- ATT 4: OVCP Forecast Profit & Loss
- ATT 5: OVCP3 Initial Stage 1 Architects Concept Drawing
- ATT 6: OVCP3 Initial Stage 1 Cost Estimate (BSM)

4. Signing Of Business Case

I confirm that the information contained in this Business Case is true and correct.

| |
|-------------|
| Signed |
| Approved by |
| Position |
| Date |

Kenn Donohoe

Chief Executive Officer

26 April 2022

WESTERN



AUSTRALIA

REGISTER NUMBER

381/DP205462DUPLICATE
EDITION
1DATE DUPLICATE ISSUED
6/1/2007VOLUME
1558FOLIO
483

RECORD OF CERTIFICATE OF TITLE

UNDER THE TRANSFER OF LAND ACT 1893

The person described in the first schedule is the registered proprietor of an estate in fee simple in the land described below subject to the reservations, conditions and depth limit contained in the original grant (if a grant issued) and to the limitations, interests, encumbrances and notifications shown in the second schedule.

BG Roberts
REGISTRAR OF TITLES



LAND DESCRIPTION:

LOT 381 ON DEPOSITED PLAN 205462

REGISTERED PROPRIETOR: (FIRST SCHEDULE)

SHIRE OF ASHBURTON OF PO BOX 567 TOM PRICE WA 6751

(T 0747604) REGISTERED 26/5/2021

LIMITATIONS, INTERESTS, ENCUMBRANCES AND NOTIFICATIONS: (SECOND SCHEDULE)

1. 63692/1964 SUBJECT TO CERTAIN MINERAL AND OTHER RESERVATIONS AS SET OUT IN TRANSFER 63692/64. REGISTERED 1/1/1964.

Warning: A current search of the sketch of the land should be obtained where detail of position, dimensions or area of the lot is required.
 * Any entries preceded by an asterisk may not appear on the current edition of the duplicate certificate of title.
 Lot as described in the land description may be a lot or location.

-----END OF CERTIFICATE OF TITLE-----

STATEMENTS:

The statements set out below are not intended to be nor should they be relied on as substitutes for inspection of the land and the relevant documents or for local government, legal, surveying or other professional advice.

SKETCH OF LAND: 1558-483 (381/DP205462)

PREVIOUS TITLE: 1504-40

PROPERTY STREET ADDRESS: NO STREET ADDRESS INFORMATION AVAILABLE.

LOCAL GOVERNMENT AUTHORITY: SHIRE OF ASHBURTON

NOTE 1: DUPLICATE CERTIFICATE OF TITLE NOT ISSUED AS REQUESTED BY DEALING
0747604

OCEAN VIEW CARAVAN PARK - PHASE 03

Lot 381 , Onslow, WA 6710 - Development Approval Set


ARCHITECTURAL SET


| | |
|------|-------------------------------------|
| A000 | COVER SHEET |
| A001 | Locality Plan |
| A010 | Master Plan |
| A011 | SW Drainage Plan |
| A012 | Landscape Plan |
| A020 | Site Sections |
| A100 | Amenities Block Layouts |
| A110 | Amenities Block Elevations |
| A200 | Barbecue Layouts |
| A210 | Barbecue Elevations |
| A400 | Bin Store and Fish Clean Layouts |
| A410 | Bin Store and Fish Clean Elevations |
| A500 | Caravan Bays - Type 01 and 02 |
| A510 | Caravan Bays - Type 03 and 04 |
| A600 | Dump Point Layout and Elevations |
| A610 | Entry Kiosk Layout and Elevations |


GENERAL NOTES
- BUILDING TO MEET CYCLONIC REGION D, TERRAIN CATEGORY 1 REQUIREMENTS.
- ALL DOOR LOCKS TO BE KEYED TO THE SHIRE MASTER KEY SYSTEM
- ALL FINISHES THROUGHOUT TO BE SUITED TO THE HIGHLY CORROSIVE ONSLOW CLIMATE
- ENTIRE FACILITY TO BE COMPLIANT AS PER AS1428
- THIS PROPERTY IS ON A SITE WHERE RECORDS CONFIRM THERE IS A HISTORY OF MILITARY ACTIVITIES THAT MAY HAVE RESULTED IN RESIDUAL UXO. NOTE THAT A POSSIBILTY EXISTS THAT DANGEROUS ITEMS OF UXO MAY STILL BE FOUND ON THIS SITE. CONTACT POLICE IF A SUSPICIOUS ITEM THAT MAY BE UXO IS FOUND






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|--|-----------------------------------|--|----------|-------------|----------------------|-----|
| | | | | | Status | Rev |
| A000 | COVER SHEET | | | 1 : 1 | DEVELOPMENT APPROVAL | C |
| Project | Ocean View Caravan Park - Phase 3 | | | | | |
| Client | Shire of Ashburton | | | | | |
| feet to range | | | | | | |
| Project Address | Lot 381, Onslow, WA 6710 | | | | | |
| Date | | | | | | |
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| architecture interior design drafting | B | Revised for Development Approval | | | | |
| | A | For Development Approval - Pre-submission Review | | | | |
| | Rev | Description | | | | |
| 2 Church Street PERTH 6000 (08) 9226 3236 admin@whitehaus.com.au | | | | | | |

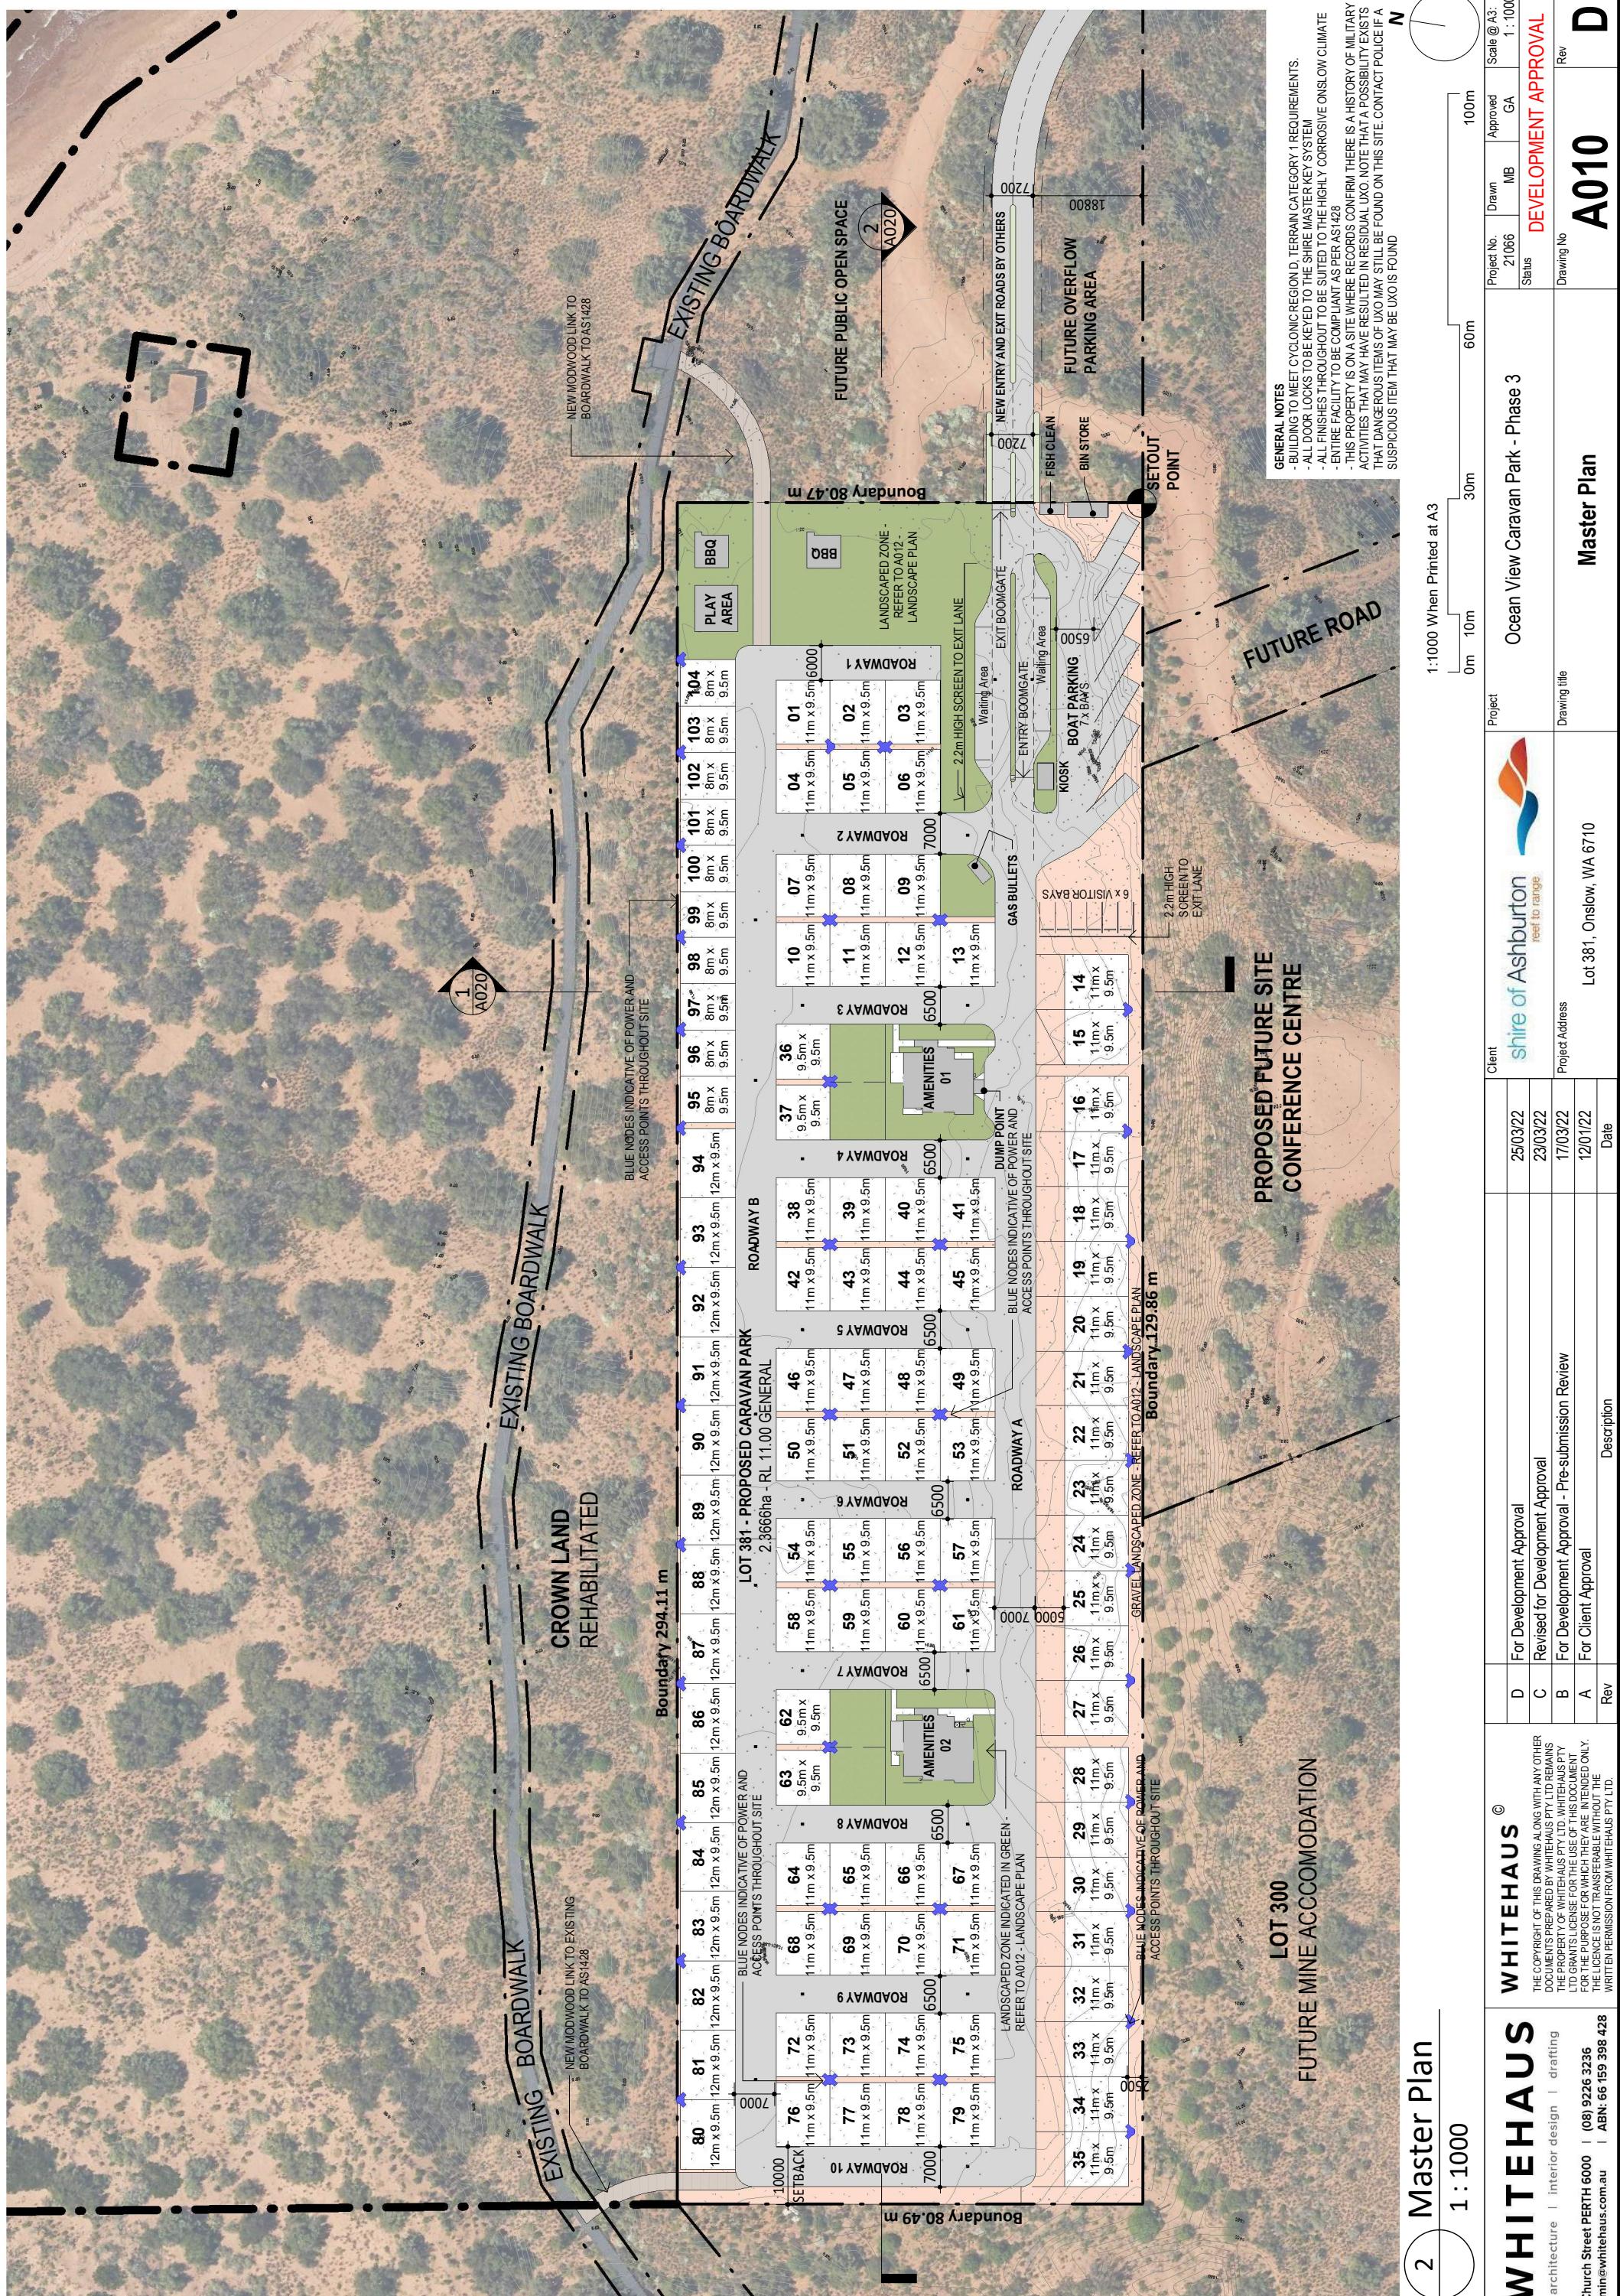

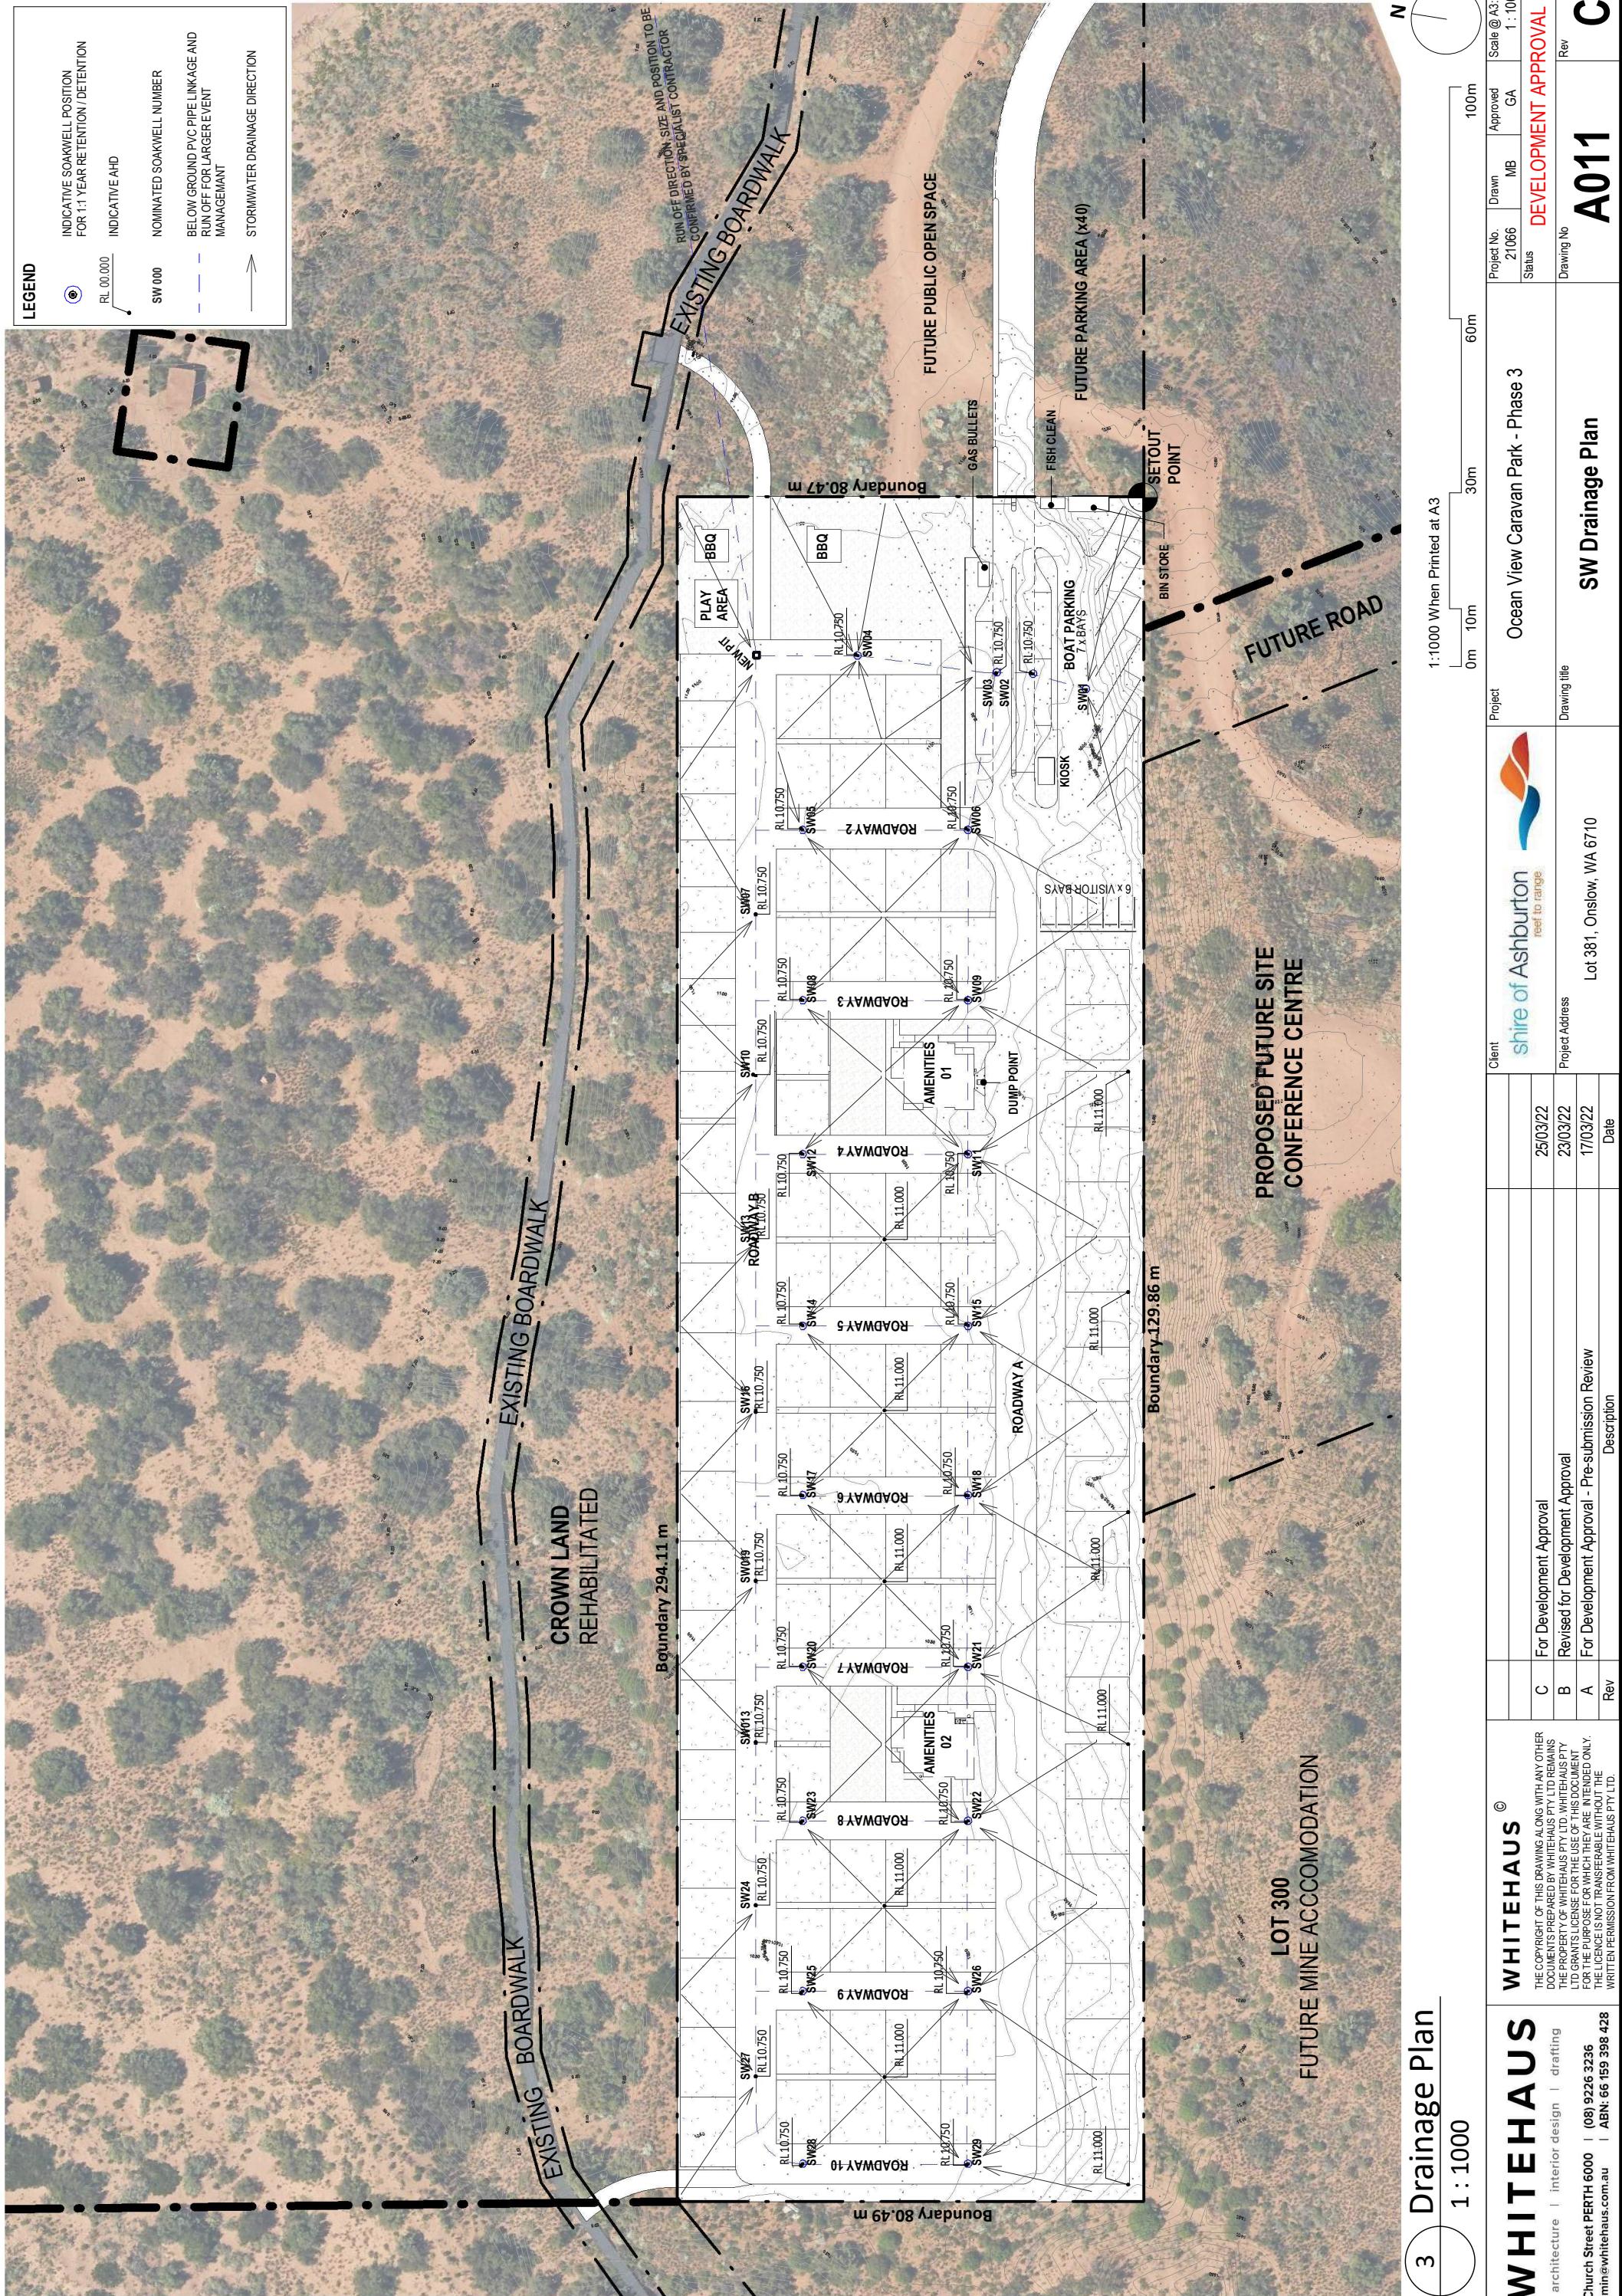

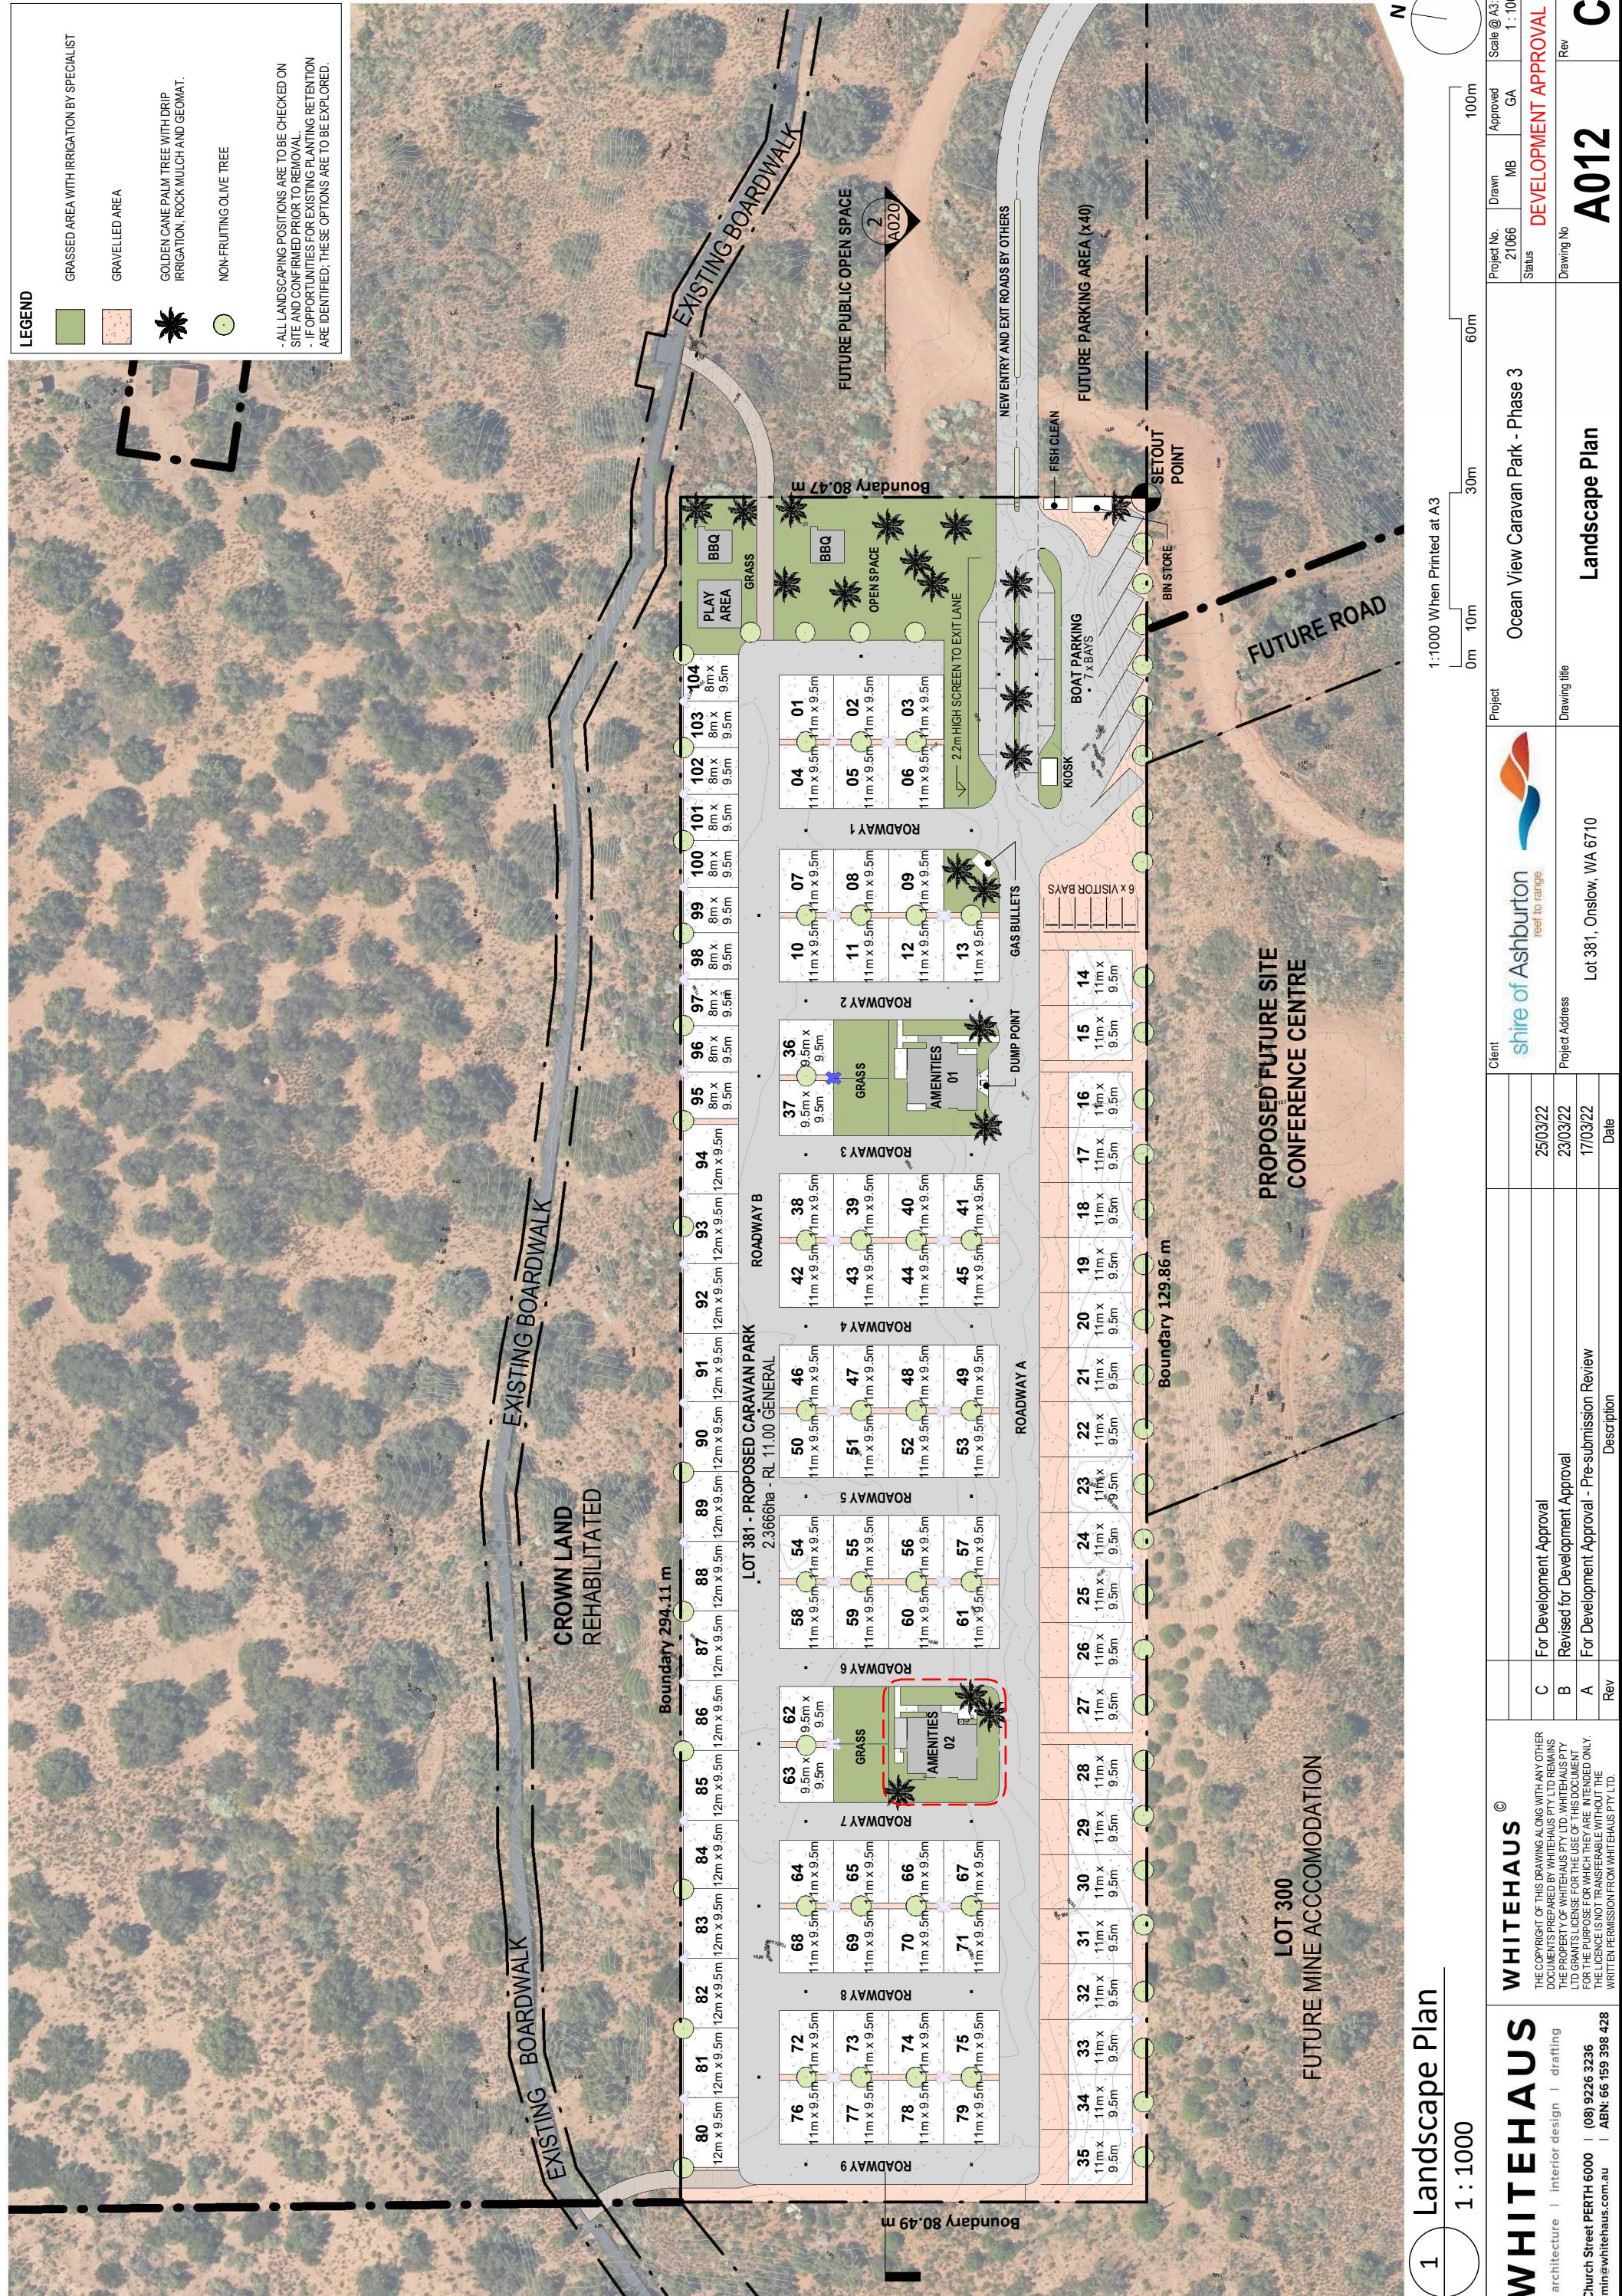


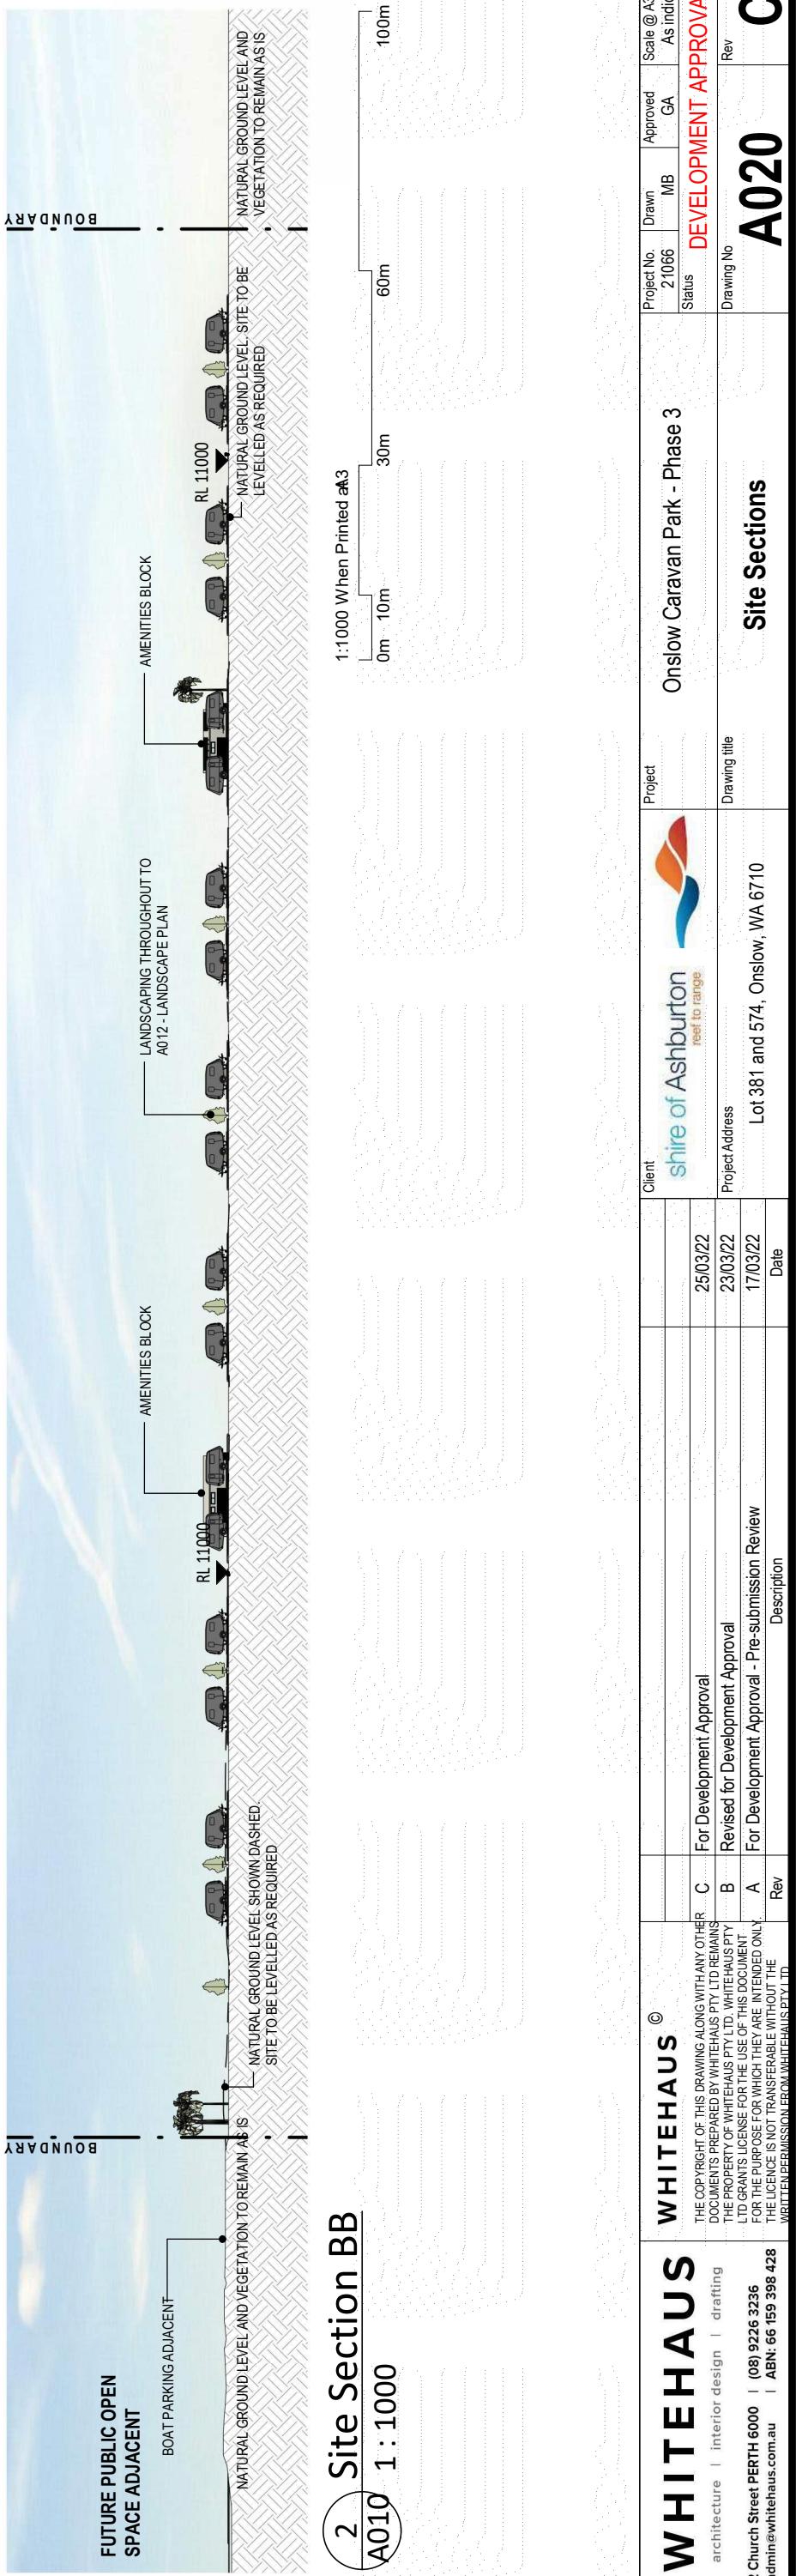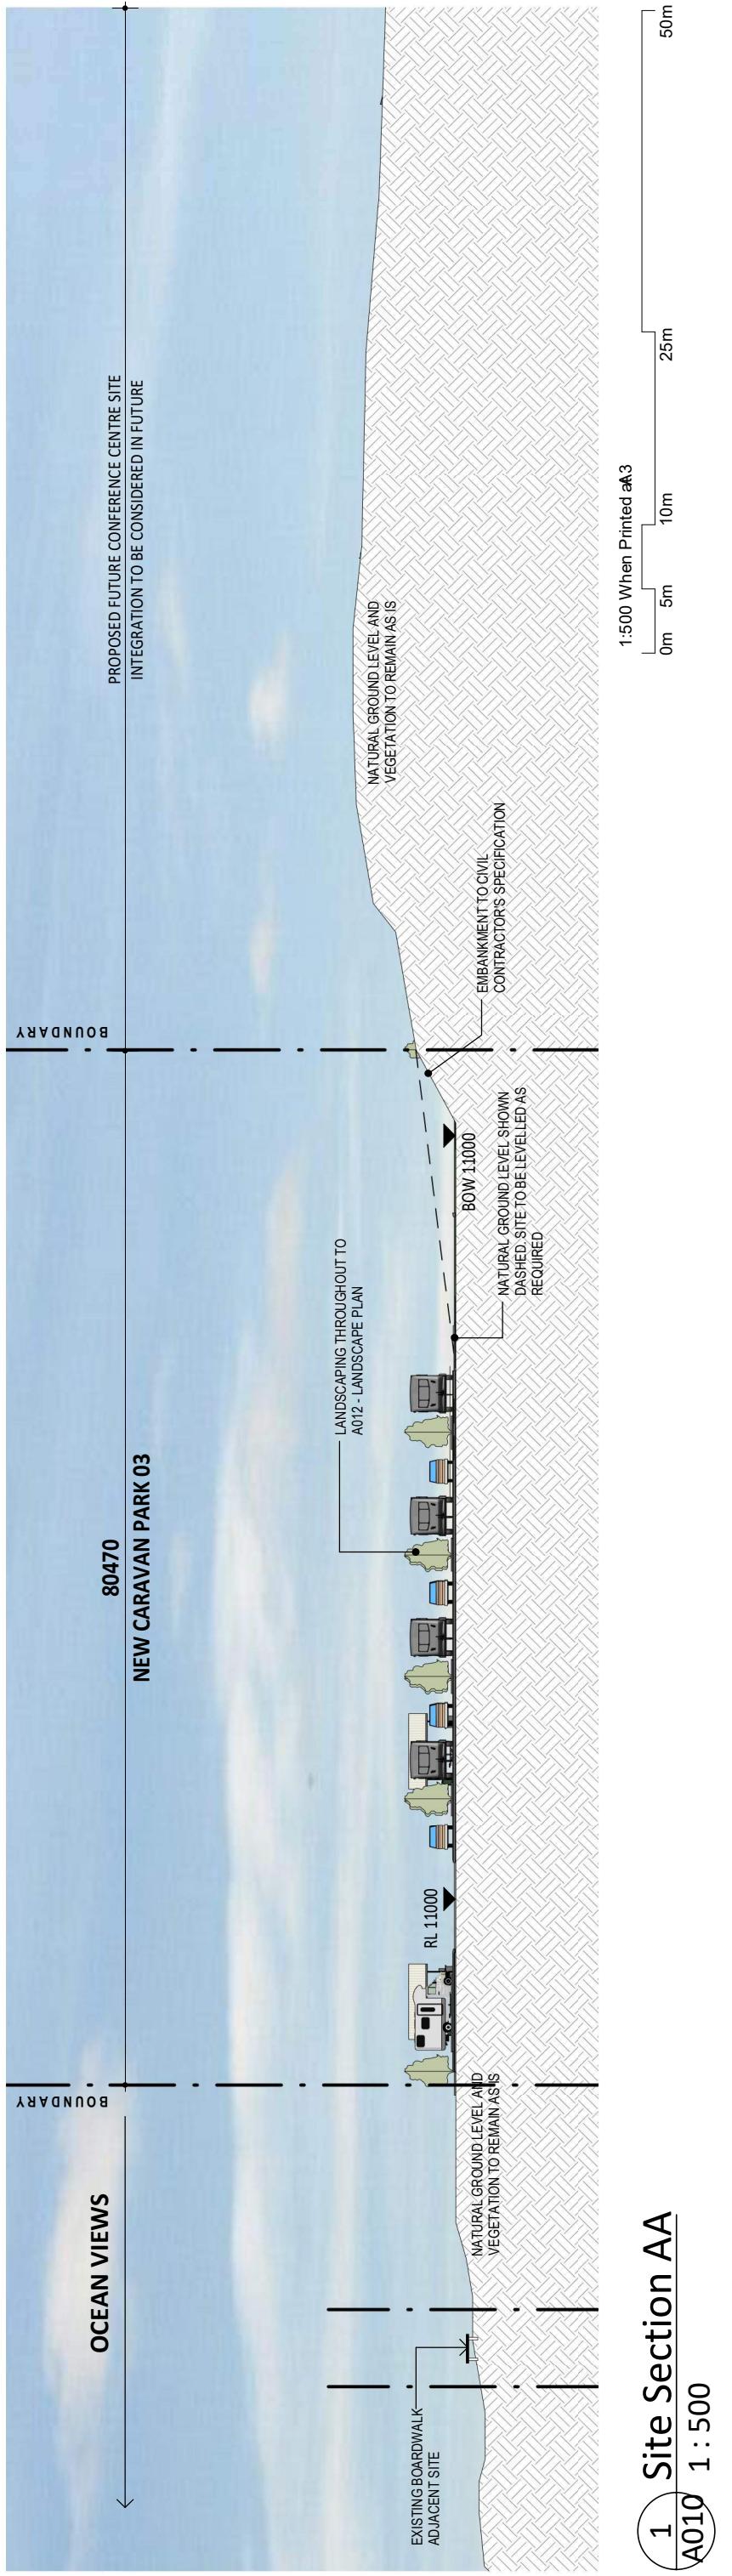

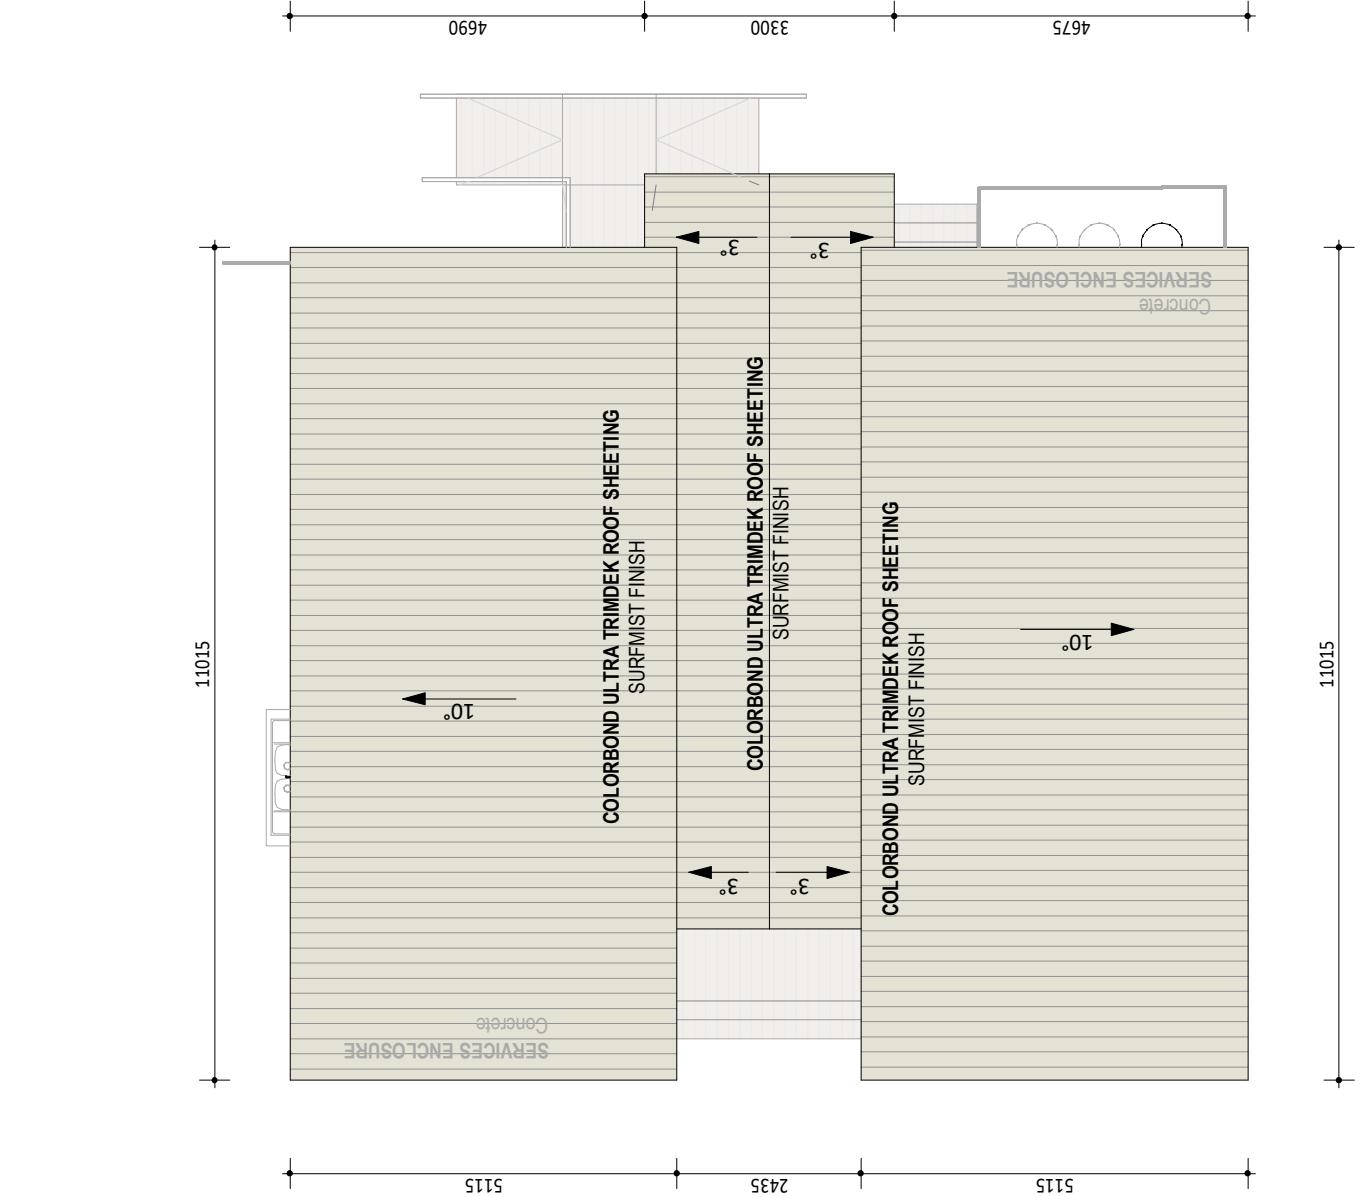

GENERAL NOTES




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 - AMENITIES BLOCK 02 HAS BEEN ILLUSTRATED FOR THE PURPOSES OF CLARITY. AMENITIES BLOCK 01 SPECIFICATION AND DIMENSIONS TO MATCH.
 - ALL DOOR LOCKS TO BE KEYED TO THE SHIRE MASTER KEY SYSTEM
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 - ENTRE FACILITY TO BE COMPLIANT AS PER AS1428

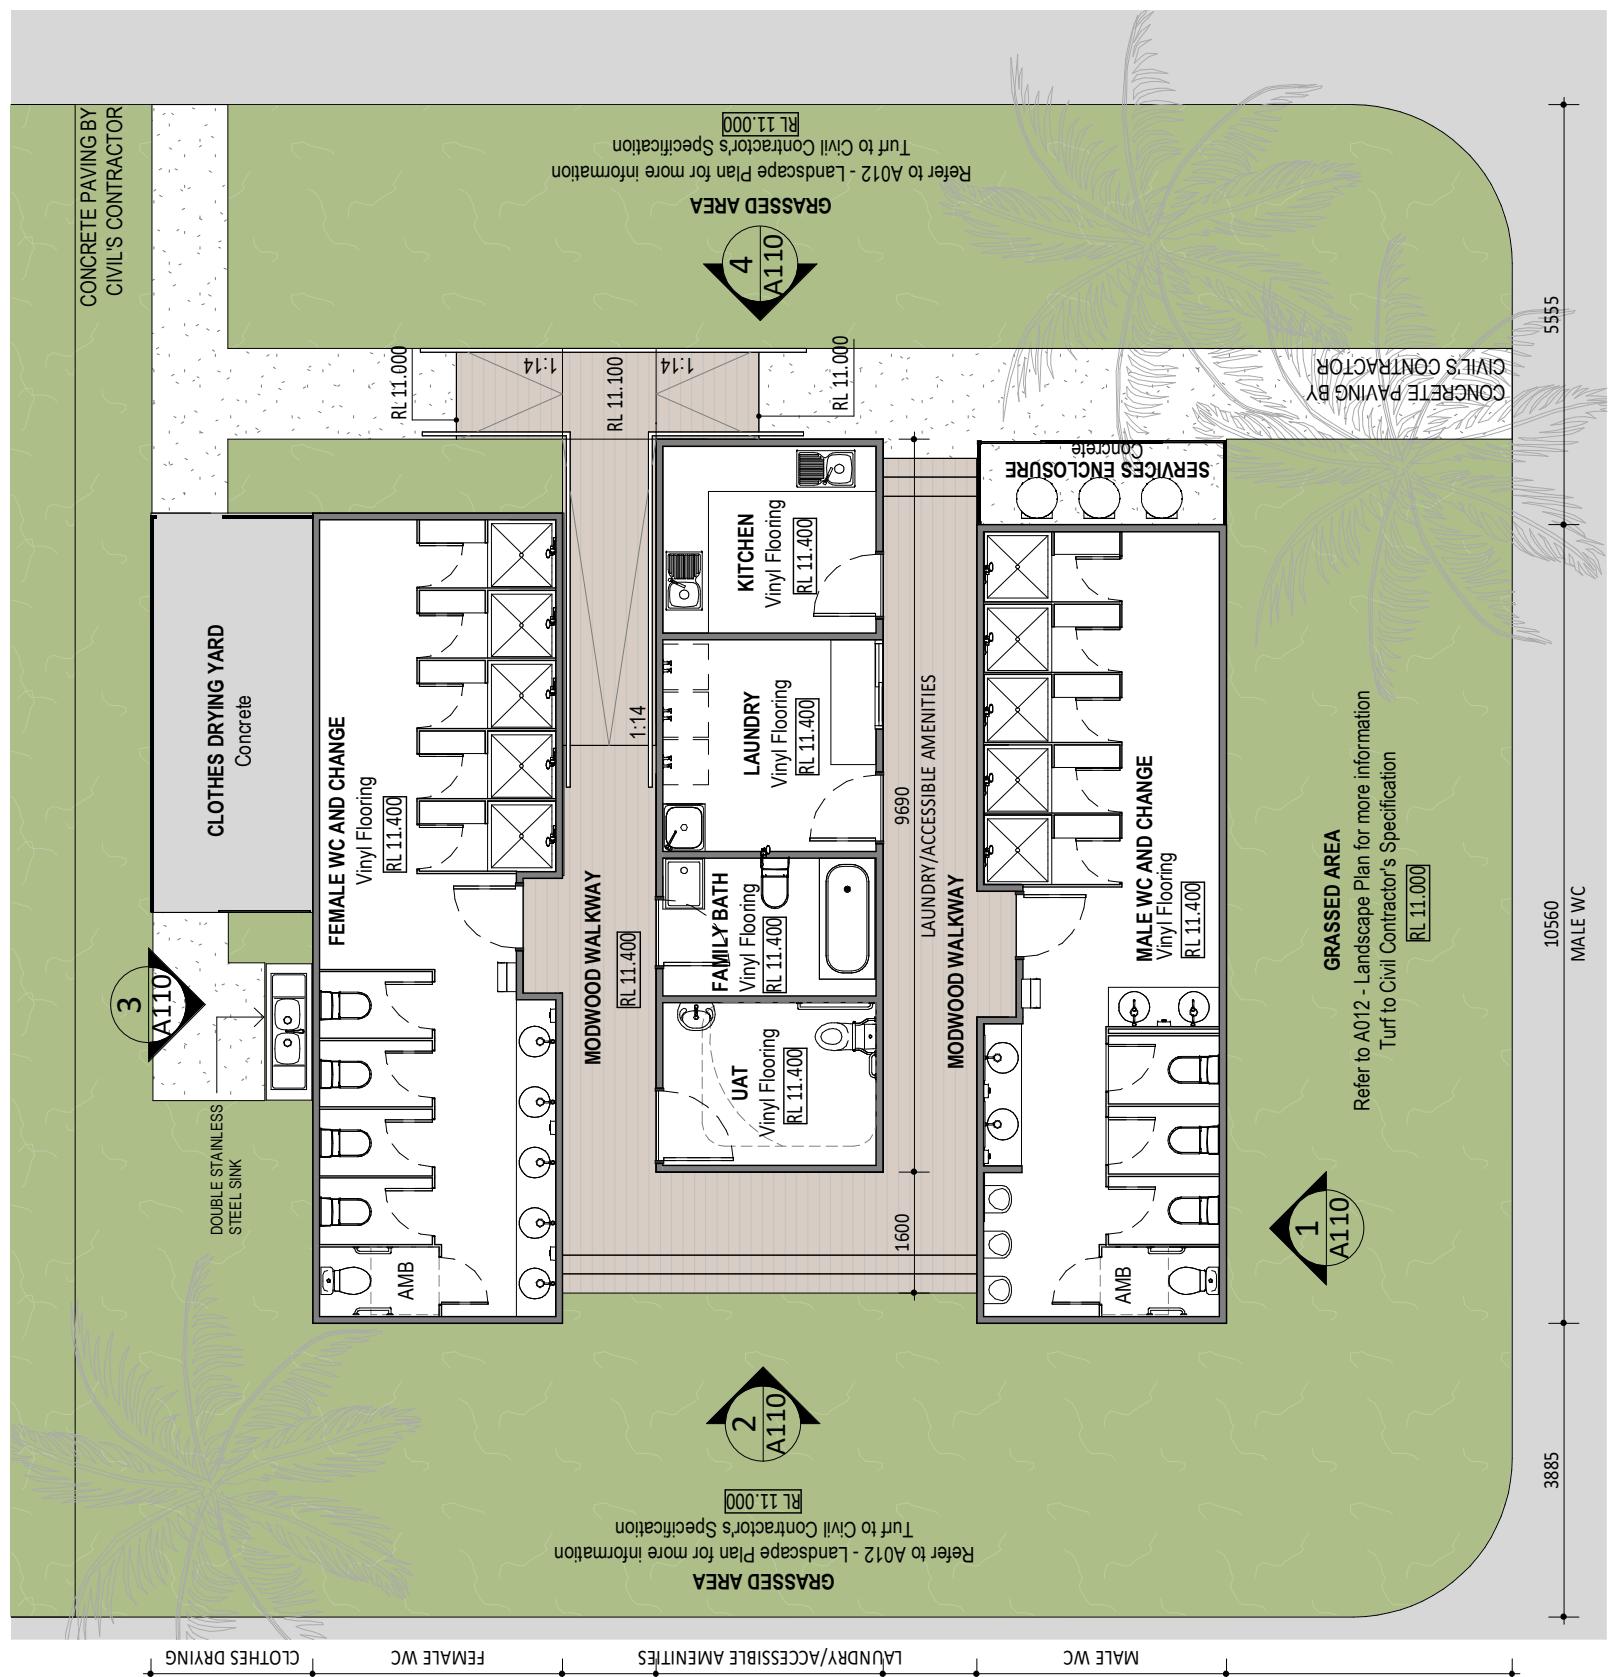

Typical Amenities Block Layout

1 : 100

| WHITEHAUS | | © | | Project | | Ocean View Caravan Park - Phase 3 | | Drawing No | | Drawing title | | Amenities Block Layouts | |
|--|----|------------------------------|----|--------------------|------------------------------|-----------------------------------|-----------------------------------|--------------------|--|--------------------|-----------------------------|-------------------------|------------------------------|
| architecture interior design drafting | | Client shire of Ashburton | | Status 21/03/22 | | Status 23/03/22 | | Status 17/03/22 | | Status 21/12/21 | | Status 20/12/21 | |
| W | H | I | T | E | H | A | U | S | F | D | R | E | V |
| 2 Church Street PERTH 6000 | | (08) 9226 3236 | | Rev | For Development Approval | E | Revised for Development Approval | D | For Development Approval - Pre-submission Review | C | Revised after client review | B | Amenities Revised for Review |
| admin@whitehaus.com.au | | ABN: 66 159 398 428 | | Revised | Client shire of Ashburton | Project | Ocean View Caravan Park - Phase 3 | Drawing No | Amenities Block Layouts | Date | Rev | F | Development Approval |
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| 1:100 When Printed at A3 | 0m | 1m | 3m | 6m | 9m | 10m |
|--------------------------|----|----|----|----|----|-----|
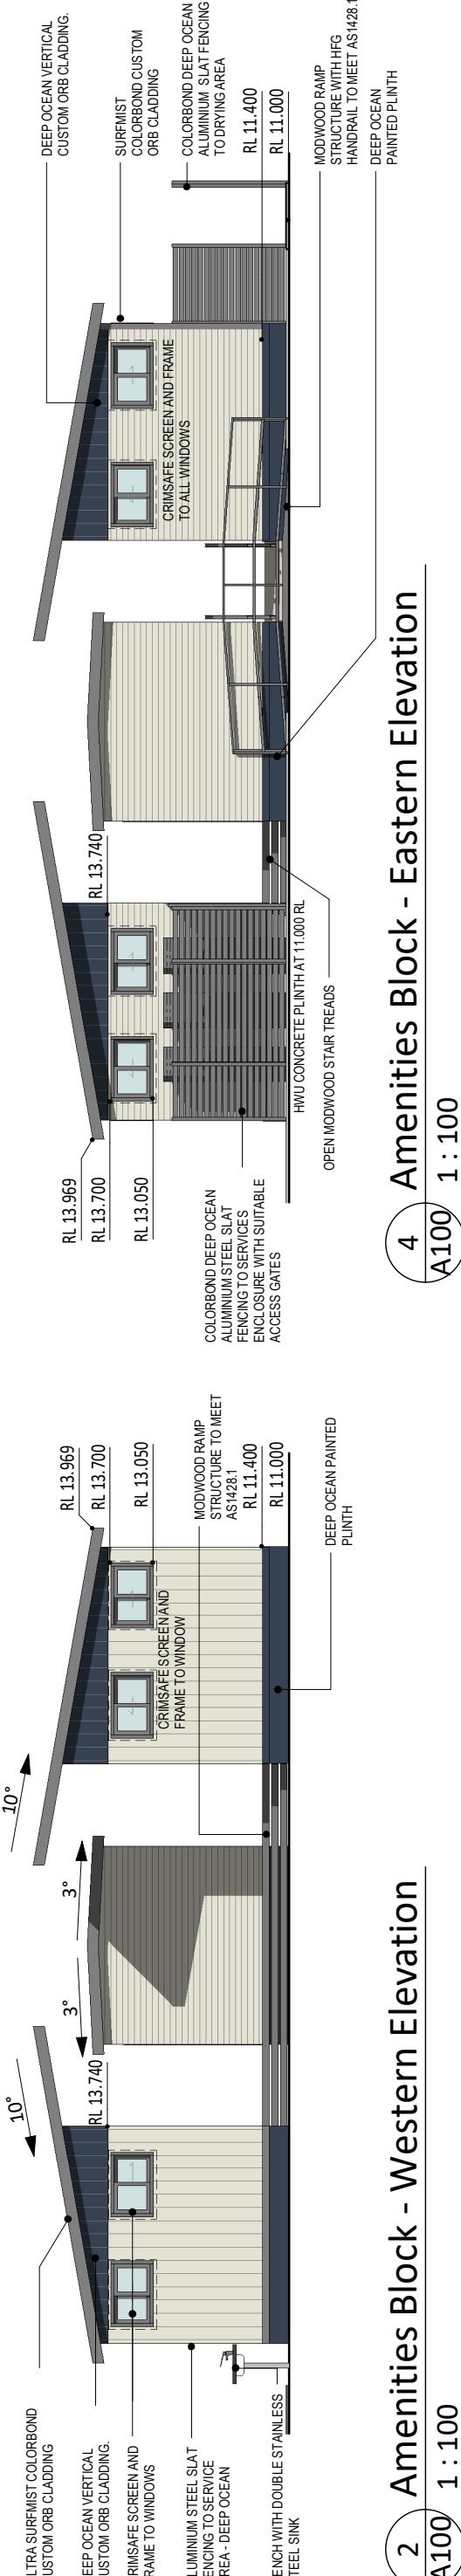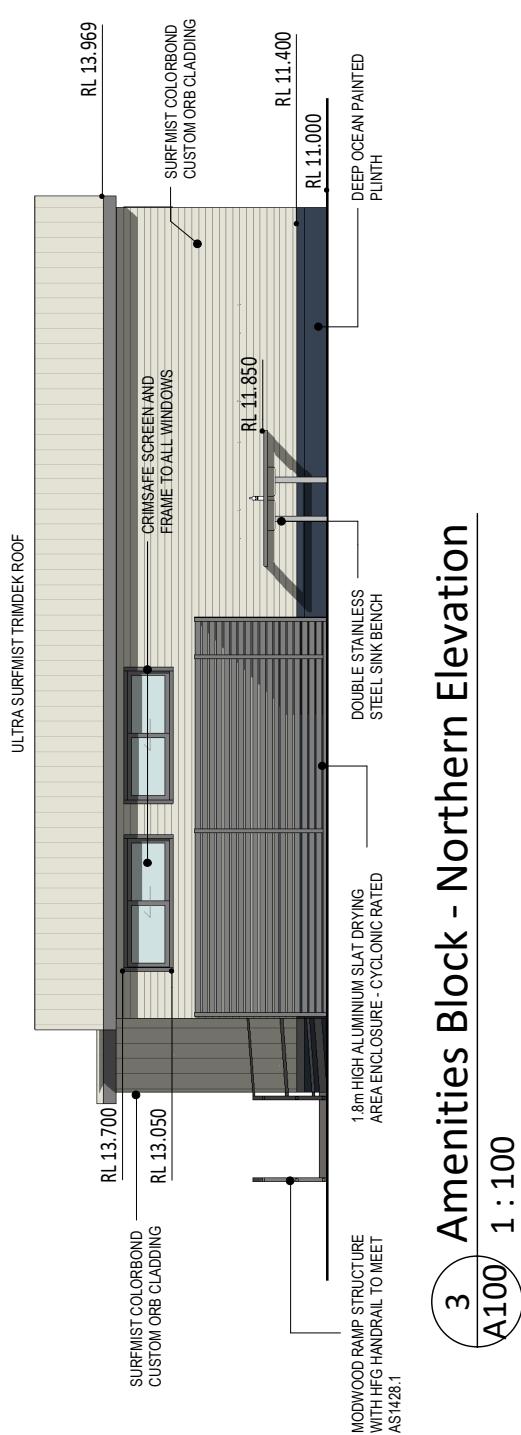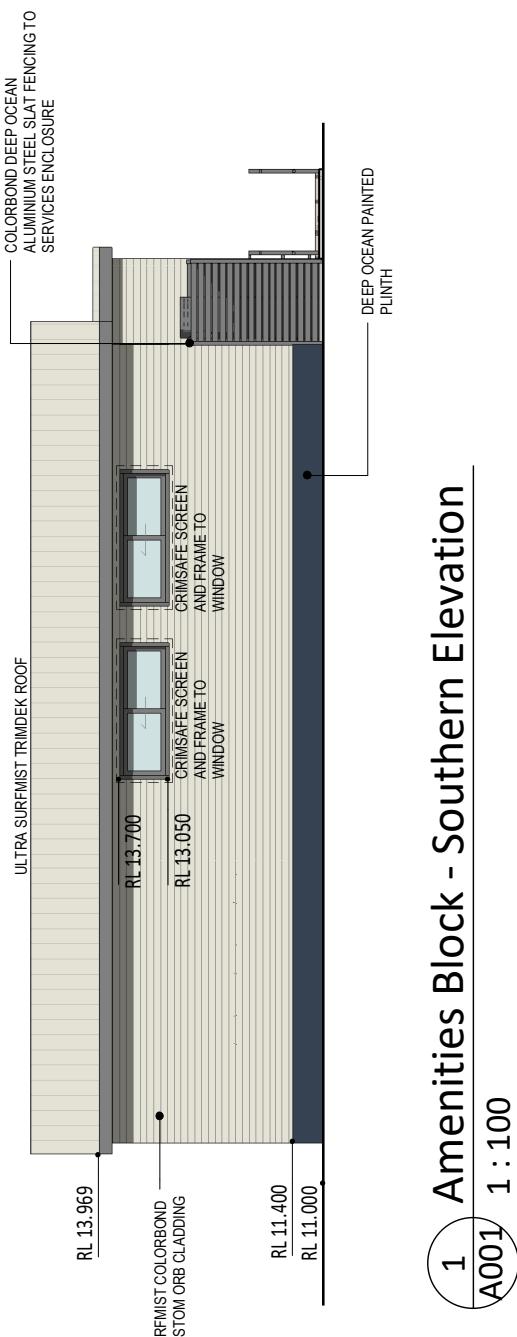
| WHITEHAUS | WHITEHAUS | Project | Ocean View Caravan Park - Phase 3 |
|-----------|------------------------|--|-----------------------------------|
| WHITEHAUS | C | For Development Approval | 25/03/22 |
| WHITEHAUS | B | Revised for Development Approval | 23/03/22 |
| WHITEHAUS | A | For Development Approval - Pre-submission Review | 17/03/22 |
| WHITEHAUS | Rev | Description | Date |
| WHITEHAUS | admin@whitehaus.com.au | 2 Church Street PERTH 6000 (08) 9226 3236 | Lot 381, Onslow, WA 6710 |

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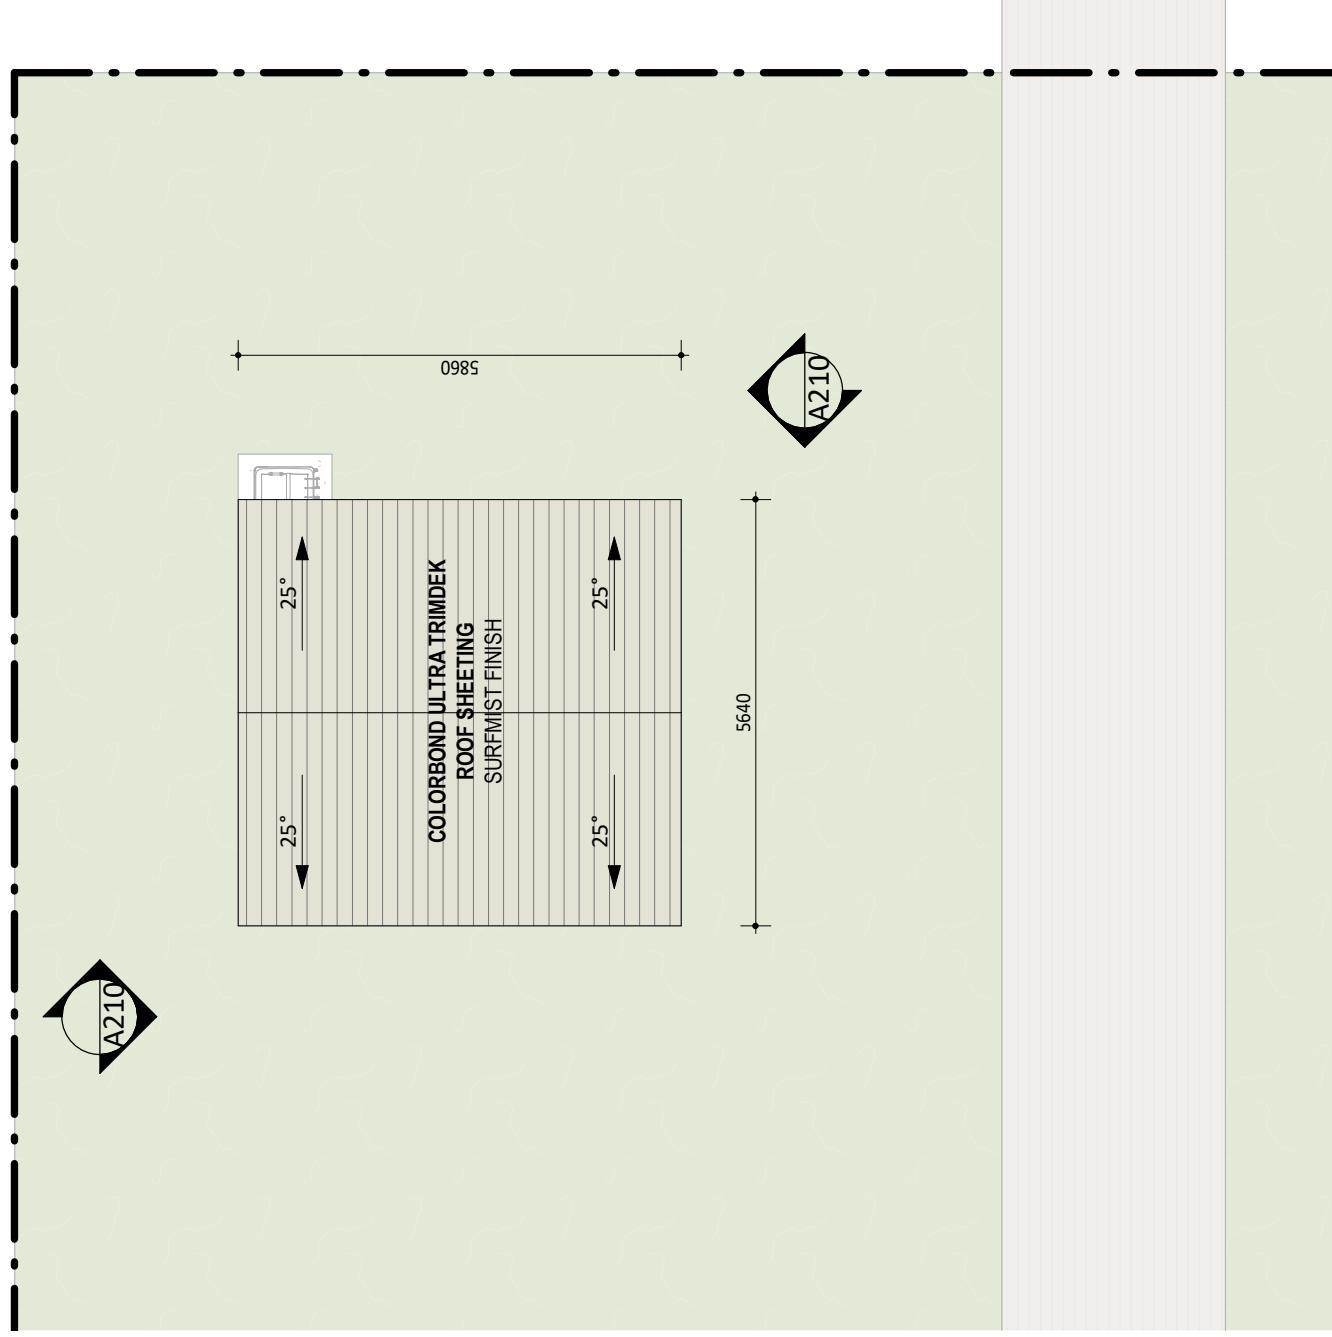
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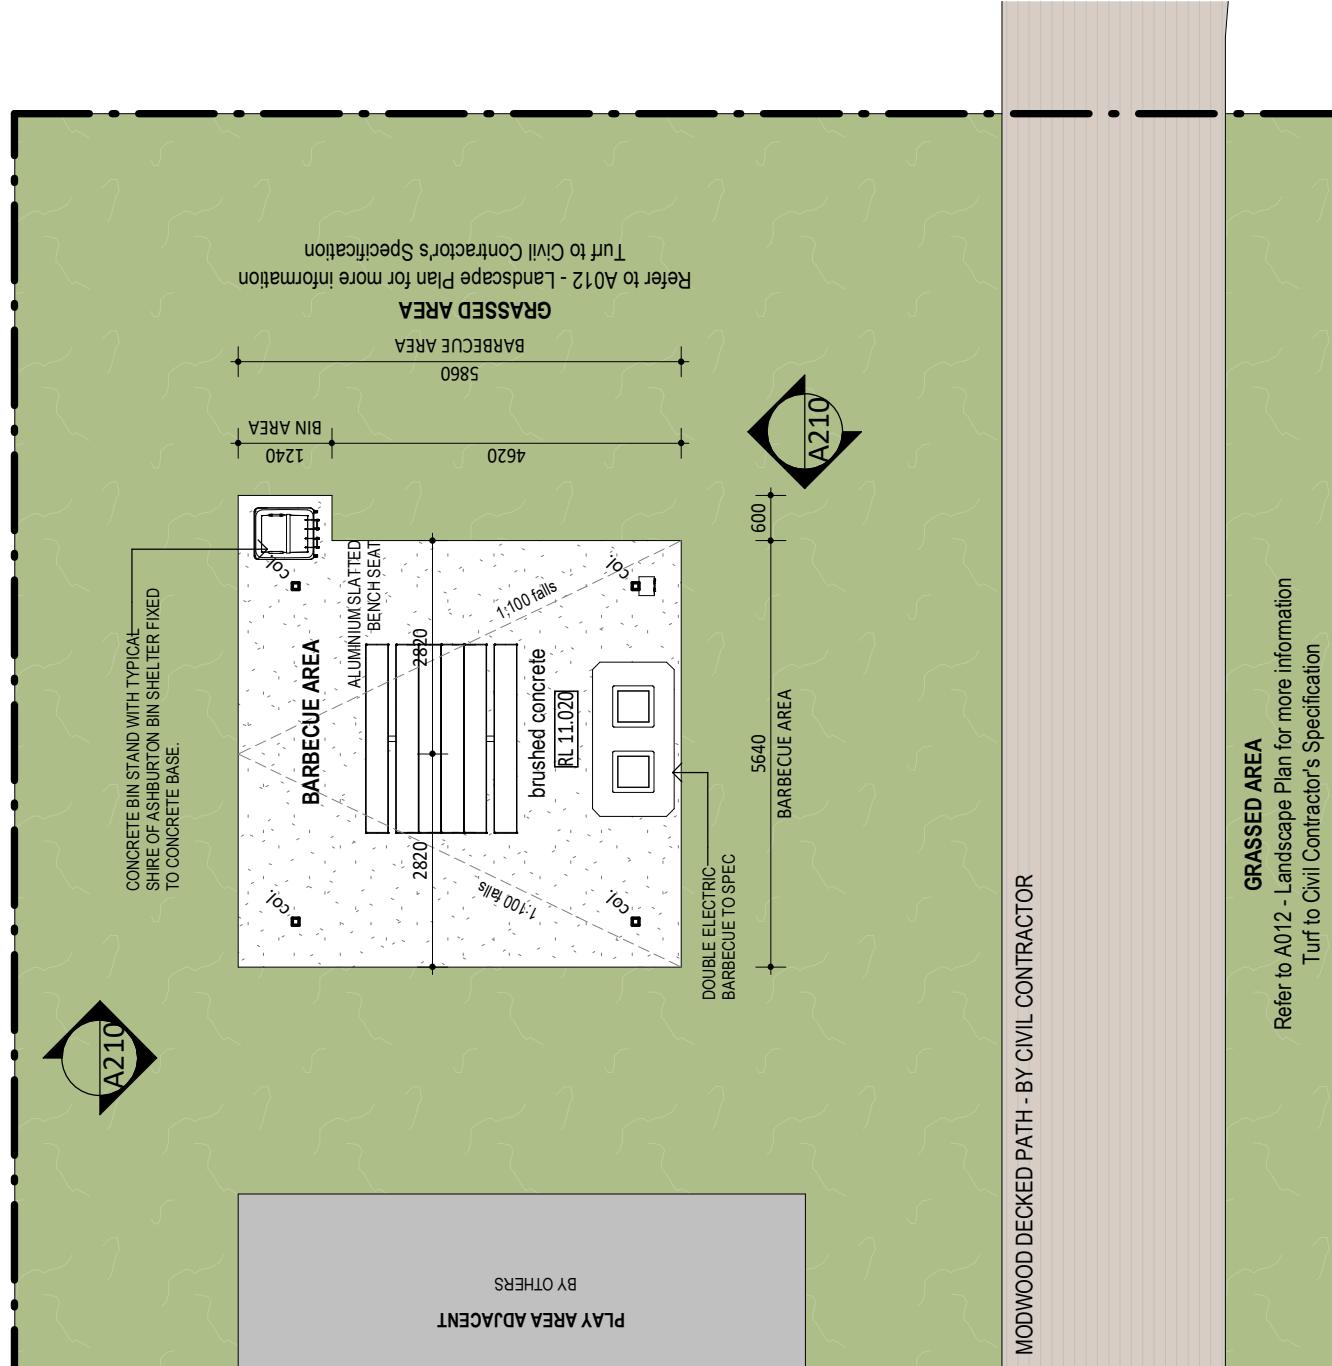
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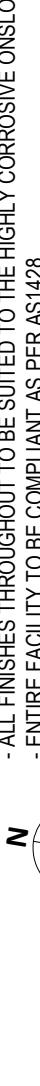
Barbecue Area Layout


MODWOOD DECKED PATH - BY CIVIL CONTRACTOR




Barber
1 : 100

GRASSED AREA
Refer to A012 - Landscape Plan for more information
-Turf to Civil Contractor's Specification


| GENERAL NOTES | |
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| - ENTIRE FACILITY TO BE COMPLIANT AS PER AS1428 | |
|  N  | 1:100 When Printed at A3 |
| WHITEHAUS © | <p>Project: Onslow Caravan Park - Phase 3</p> <p>Client: Shire of Ashburton <small>ref: t1 range</small></p> <p>Project No.: 21066</p> <p>Drawn: MB</p> <p>Approved: GA</p> <p>Scale @ A3: 1: 100</p> |
| architecture interior design drafting | <p>Status: DEVELOPMENT APPROVAL</p> <p>Drawing No:</p> <p>Date: 17/03/22</p> |
| WHITEHAUS | <p>Barbecue Layouts</p> <p>Rev: C</p> |

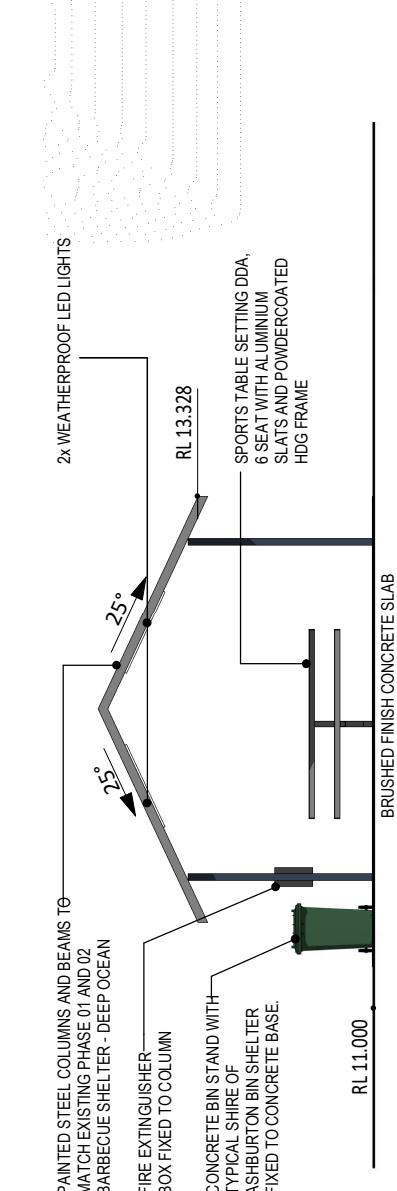

1 Barbecue - Northern Elevation
A200 1:100

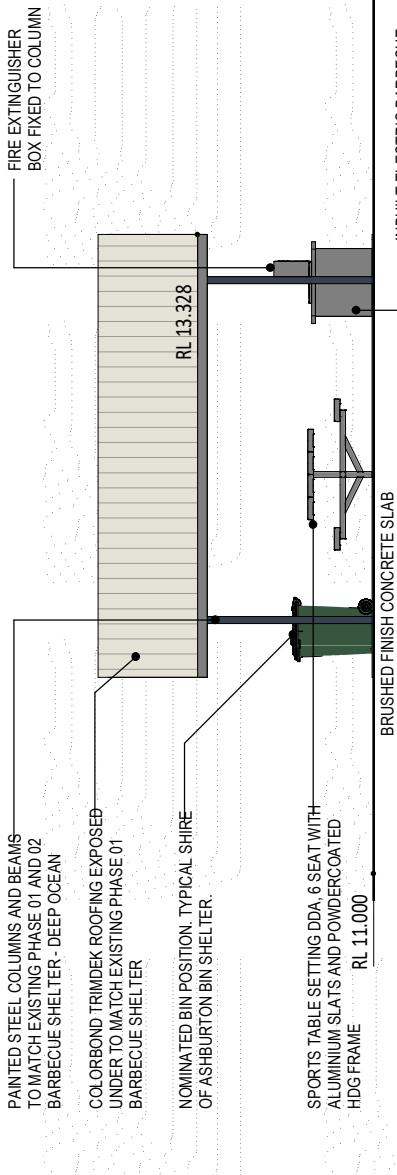

3 Barbecue - Western Elevation
A200 1:100

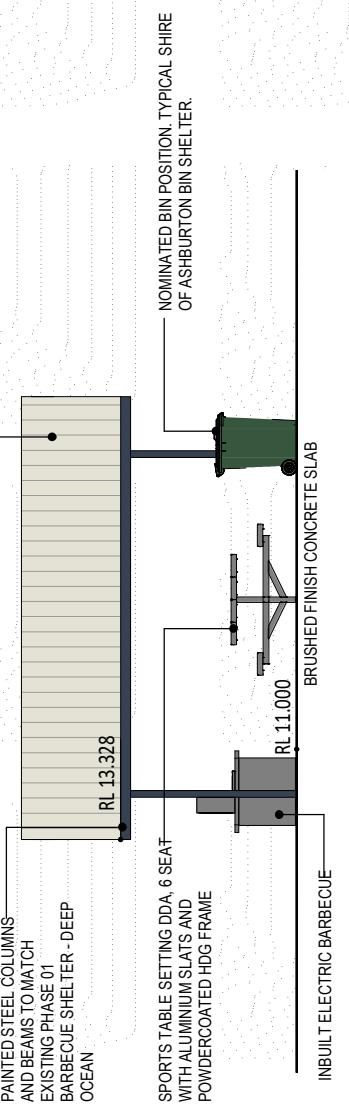

2 Barbecue - Southern Elevation
A200 1:100



EXISTING PHASE 01 BARBECUE AREA FINISHES TO BE MATCHED



Barbecue Elevations
A210

GENERAL NOTES
- ALL STRUCTURES TO MEET CYCLONIC REGION D, TERRAIN CATEGORY 1 REQUIREMENTS
- ALL FINISHES THROUGHOUT TO BE SUITED TO THE HIGHLY CORROSIVE ONSLOW CLIMATE
- ENTIRE FACILITY TO BE COMPLIANT AS PER AS1428

| Project No. | Drawn | Approved | Scale @ A3: |
|-------------|-----------------------------|----------|-------------|
| 21066 | MB | GA | 1:100 |
| Status | DEVELOPMENT APPROVAL | | |
| Rev | | | |

Drawing No. Drawing title
Lot 381 and 574, Onslow, WA 6710
Barbecue Elevations
A210

C

GENERAL NOTES
 - ALL STRUCTURES TO MEET CYCLONIC REGION D, TERRAIN CATEGORY 1 REQUIREMENT.
 - ALL FINISHES THROUGHOUT TO BE SUITED TO THE HIGHLY CORROSION ONSLOW CLIMATE
 - ENTIRE FACILITY TO BE COMPLIANT AS PER AS1428



N

1:100 When Printed A3

10m
6m
3m
0m

Project No. 21066 Drawn MB Approved GA Scale @ A3: 1:100

Status **DEVELOPMENT APPROVAL**

Rev

C

GENERAL NOTES

- ALL STRUCTURES TO MEET CYCLONIC REGION D, TERRAIN CATEGORY 1 REQUIREMENT.

- ALL FINISHES THROUGHOUT TO BE SUITED TO THE HIGHLY CORROSION ONSLOW CLIMATE

- ENTIRE FACILITY TO BE COMPLIANT AS PER AS1428



N

1:100 When Printed A3

10m
6m
3m
0m

Project No. 21066 Drawn MB Approved GA Scale @ A3: 1:100

Status **DEVELOPMENT APPROVAL**

Rev

C

2 Bin Store and Fish Clean - Roof Plan

1 : 100

1 Bin Store and Fish Clean Layout



1 : 100

2 Bin Store and Fish Clean - Roof Plan


1 : 100

1 Bin Store and Fish Clean Layout


1 : 100

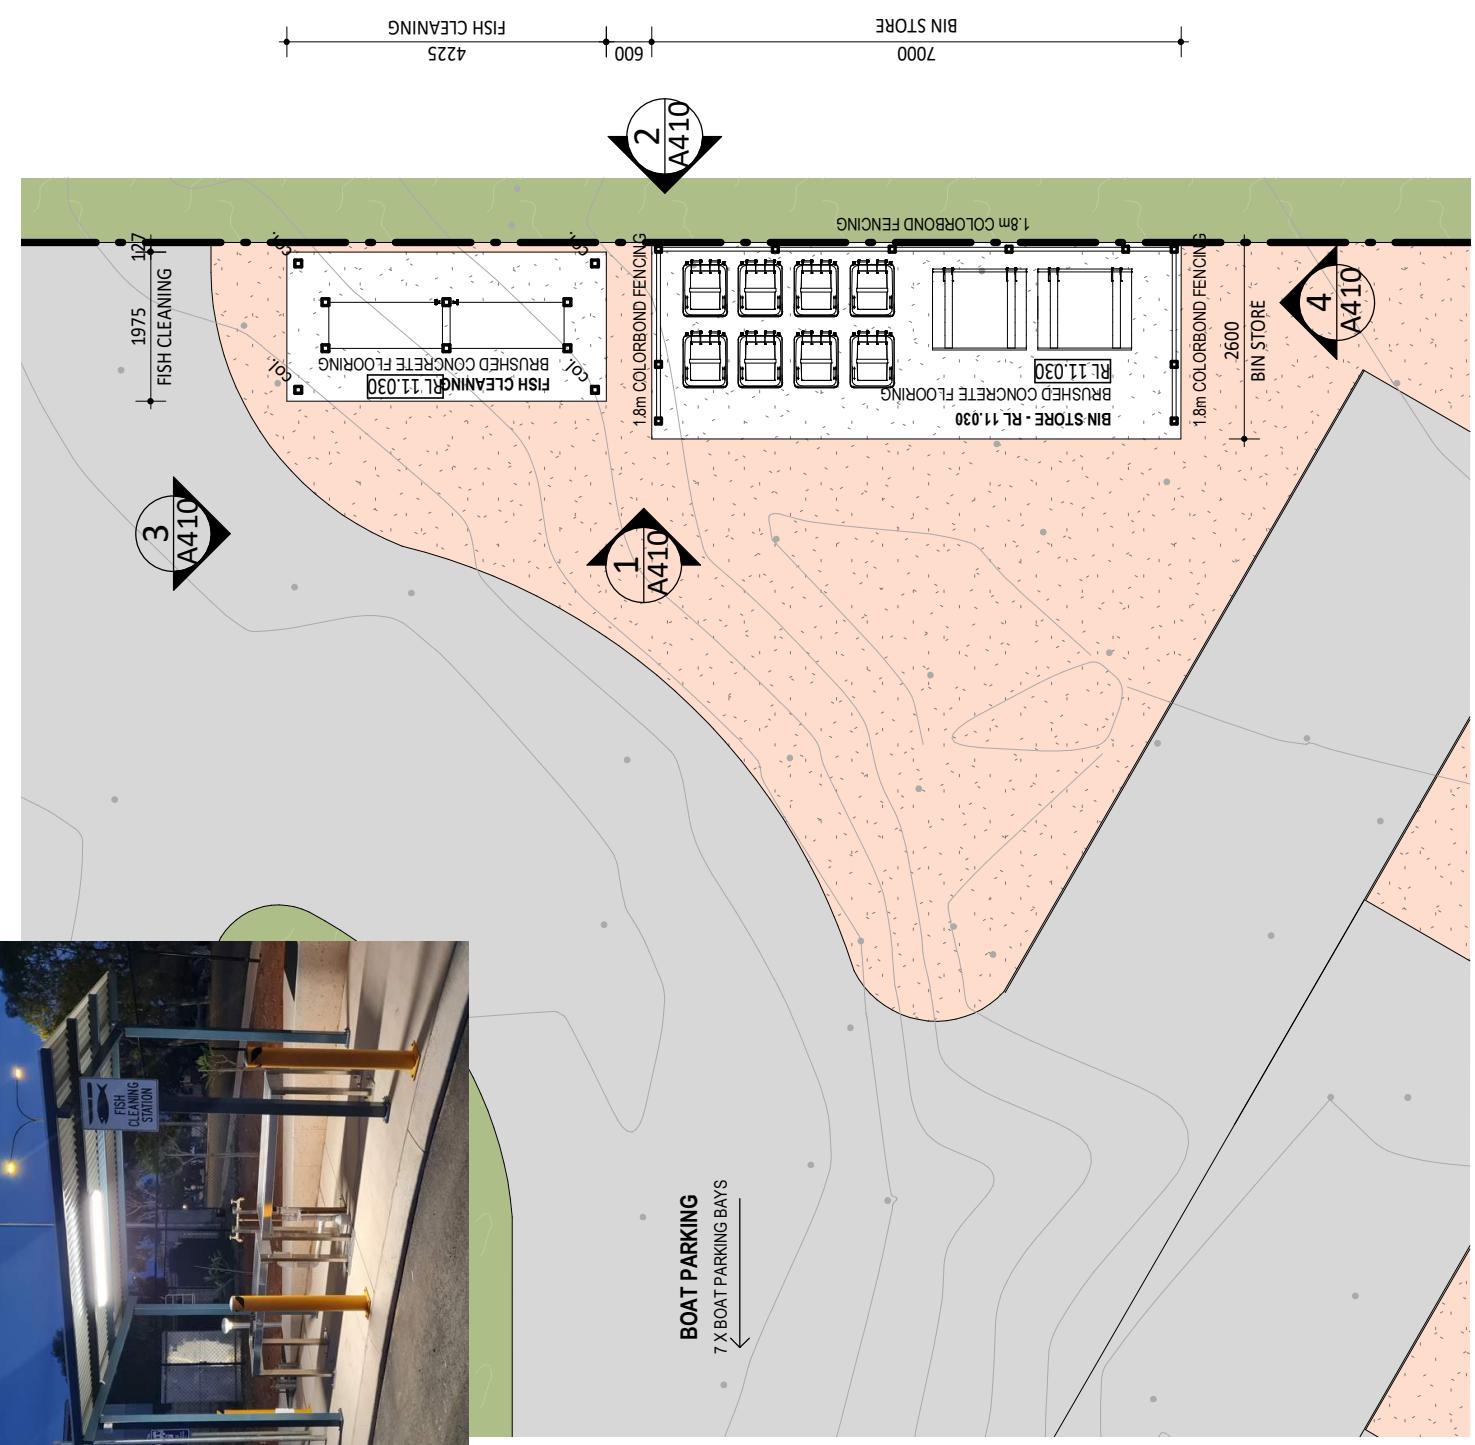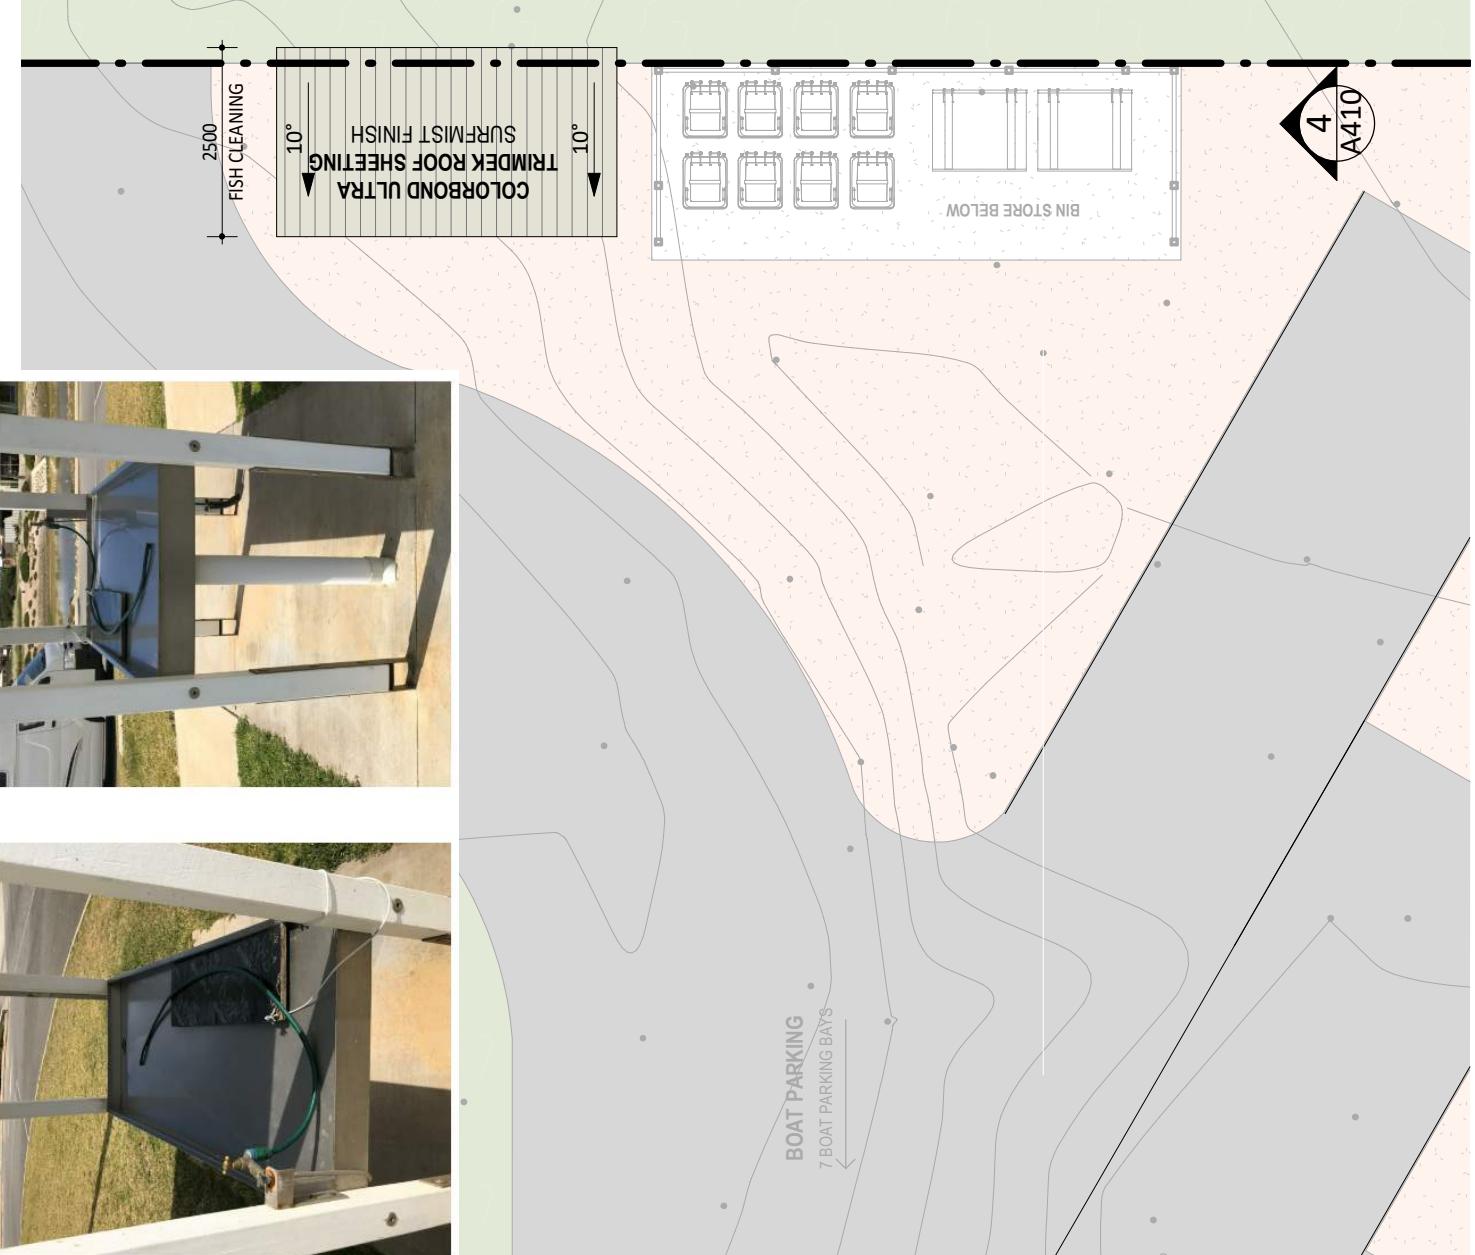


| WHITEHAUS | WHITEHAUS | © | WHITEHAUS | | | Client Shire of Ashburton feet to range | Project Onslow Caravan Park - Phase 3 |
|---|---------------------|----------------|--|--|-----|--|---|
| | | | C | B | A | | |
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| architecture | interior design | drafting | C | B | A | For Development Approval | Revised for Development Approval |
| 2 Church Street PERTH 6000 | ABN: 66 159 398 428 | (08) 9226 3236 | For Development Approval - Pre-submission Review | For Development Approval - Pre-submission Review | Rev | 25/03/22 | 23/03/22 |
| admin@whitehaus.com.au | | | Date | Description | | 17/03/22 | |

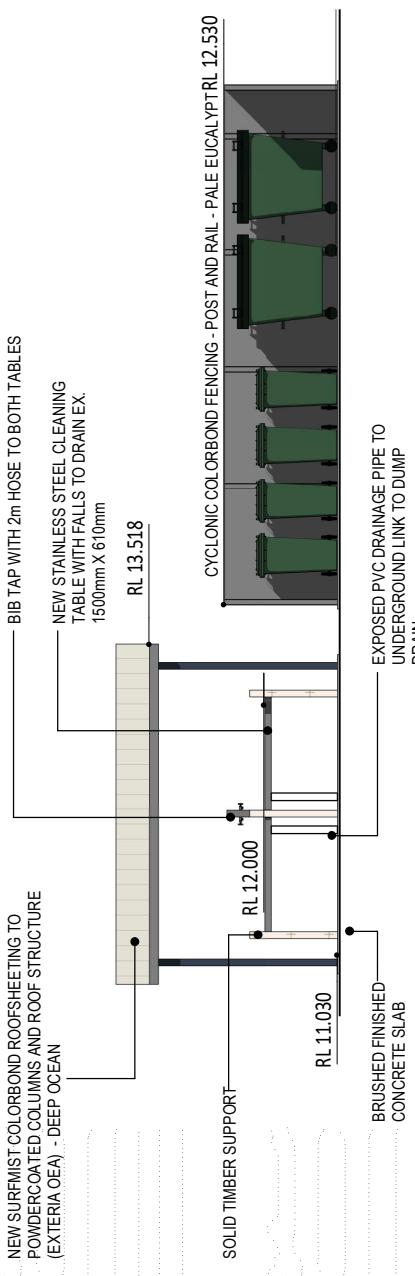


1 Fish Clean and Bin Store - Western Elevation
A400 1 : 100

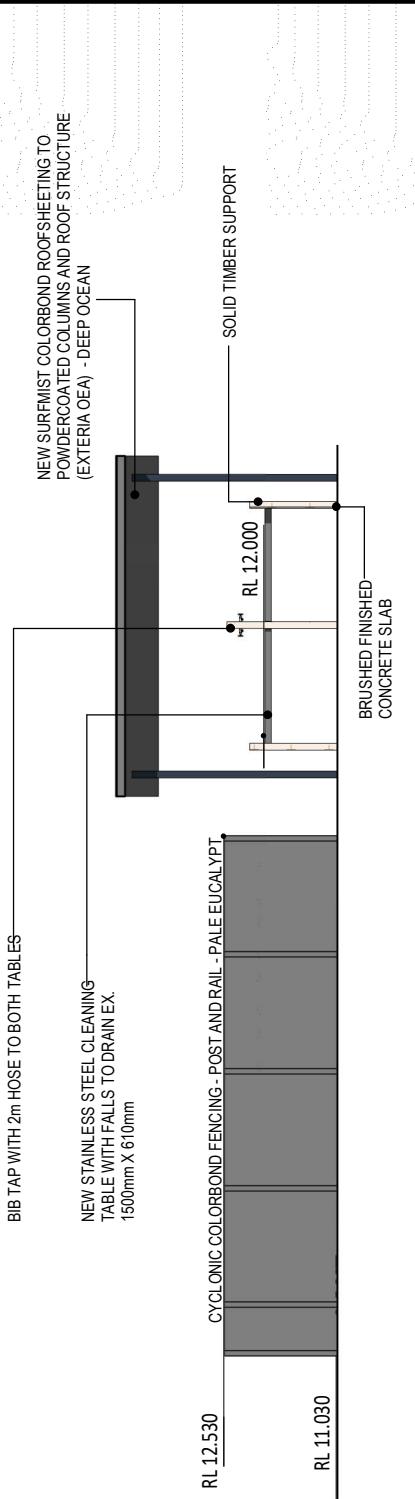

2 Fish Clean and Bin Store - Eastern Elevation
A400 1 : 100

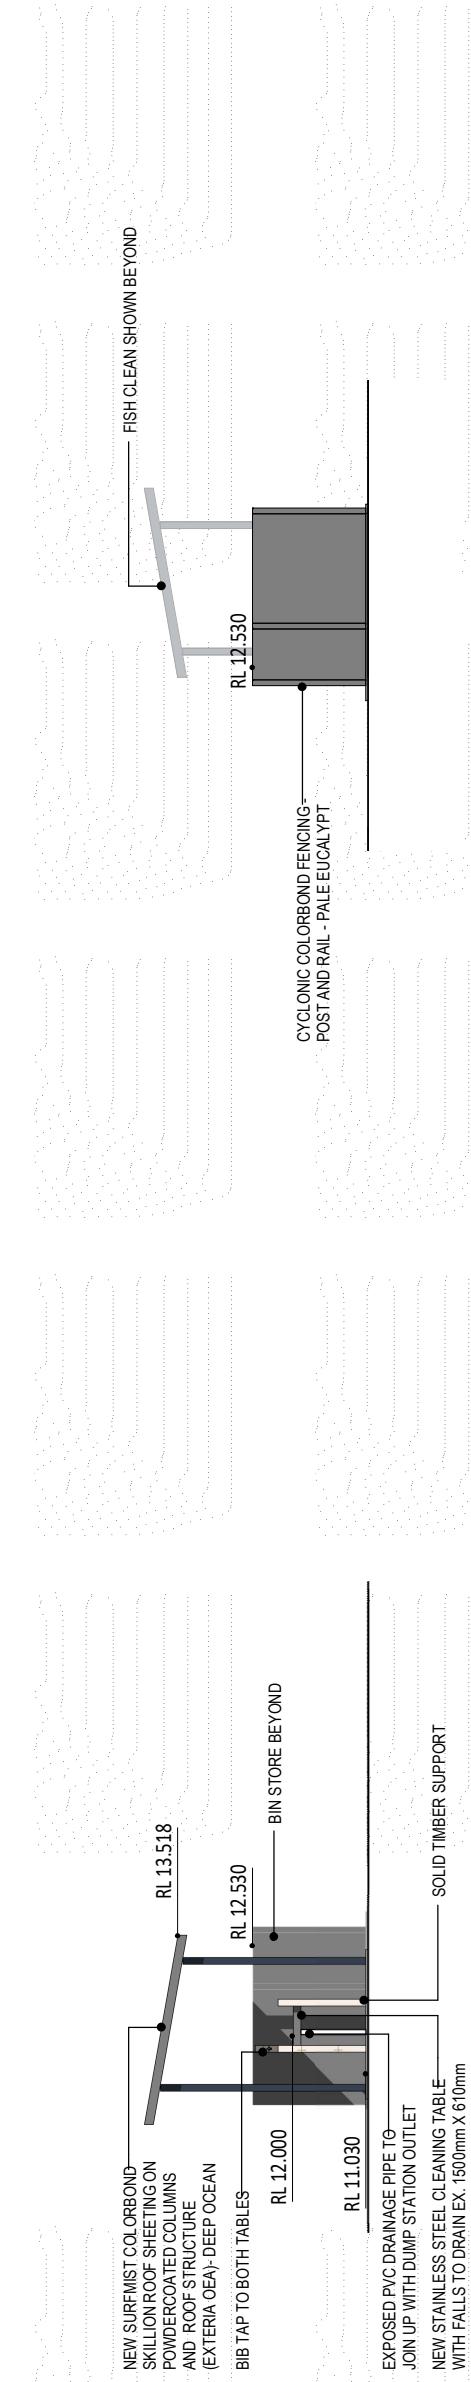



3 Fish Clean and Bin Store - Northern Elevation
A401 1 : 100

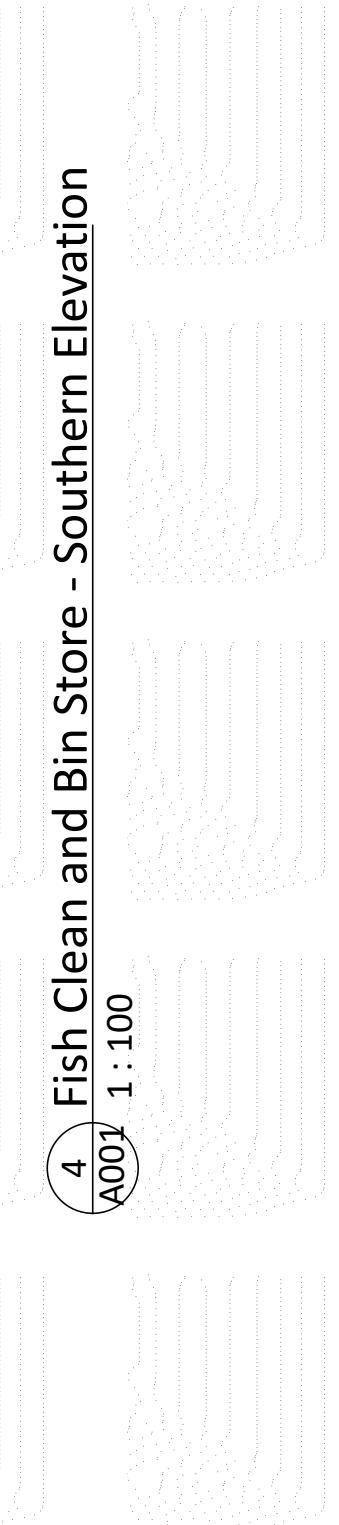

4 Fish Clean and Bin Store - Southern Elevation
A401 1 : 100

| Project No. | Drawn | MB | Approved | Scale @ A3: | Client | |
|-------------|-------|----|----------|-------------|--------------------|-------------------------------------|
| | | | | | GA | 1:100 |
| 21066 | | | | | shire of Ashburton | feet to range |
| 230322 | | | | | Project Address | 25/03/22 |
| 230322 | | | | | Drawing title | Development Approval |
| 17/03/22 | | | | | Date | Rev |
| | | | | | | Bin Store and Fish Clean Elevations |
| | | | | | | A410 |

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architecture | interior design | drafting
2 Church Street PERTH 6000 | (08) 9226 3236
admin@whitehaus.com.au | ABN: 66 159 398 428

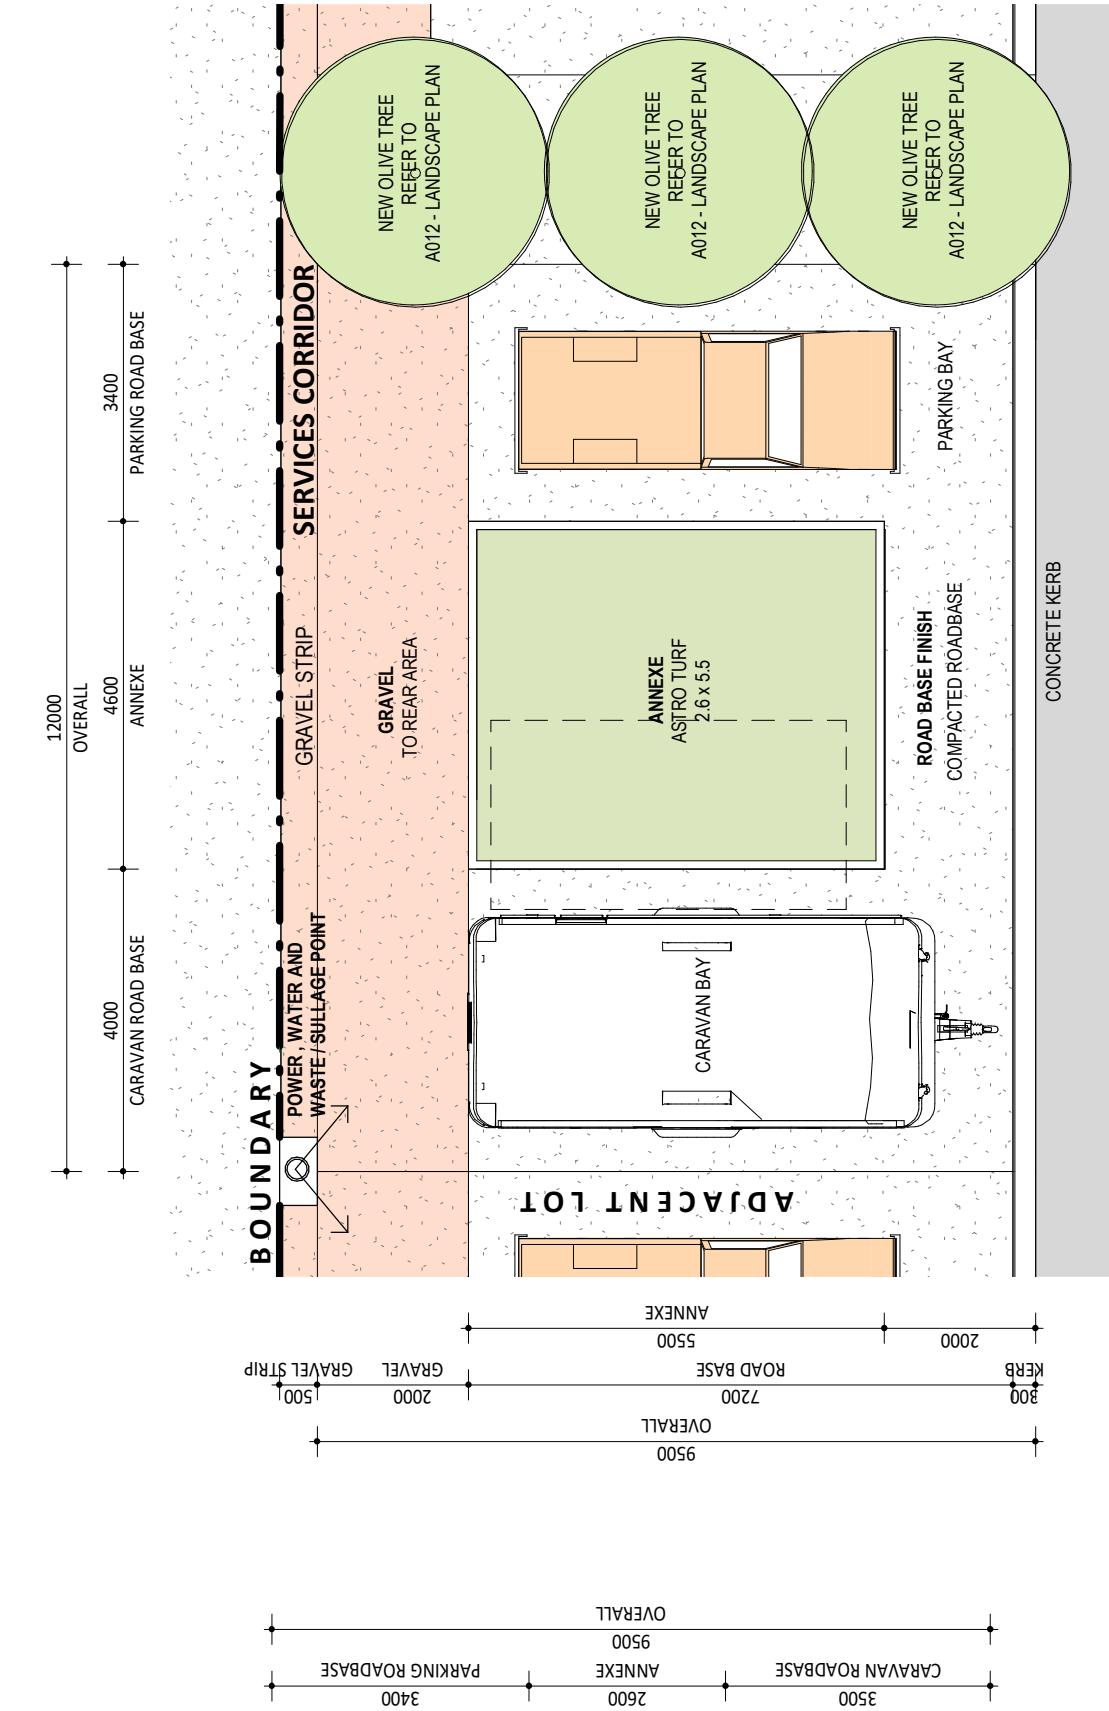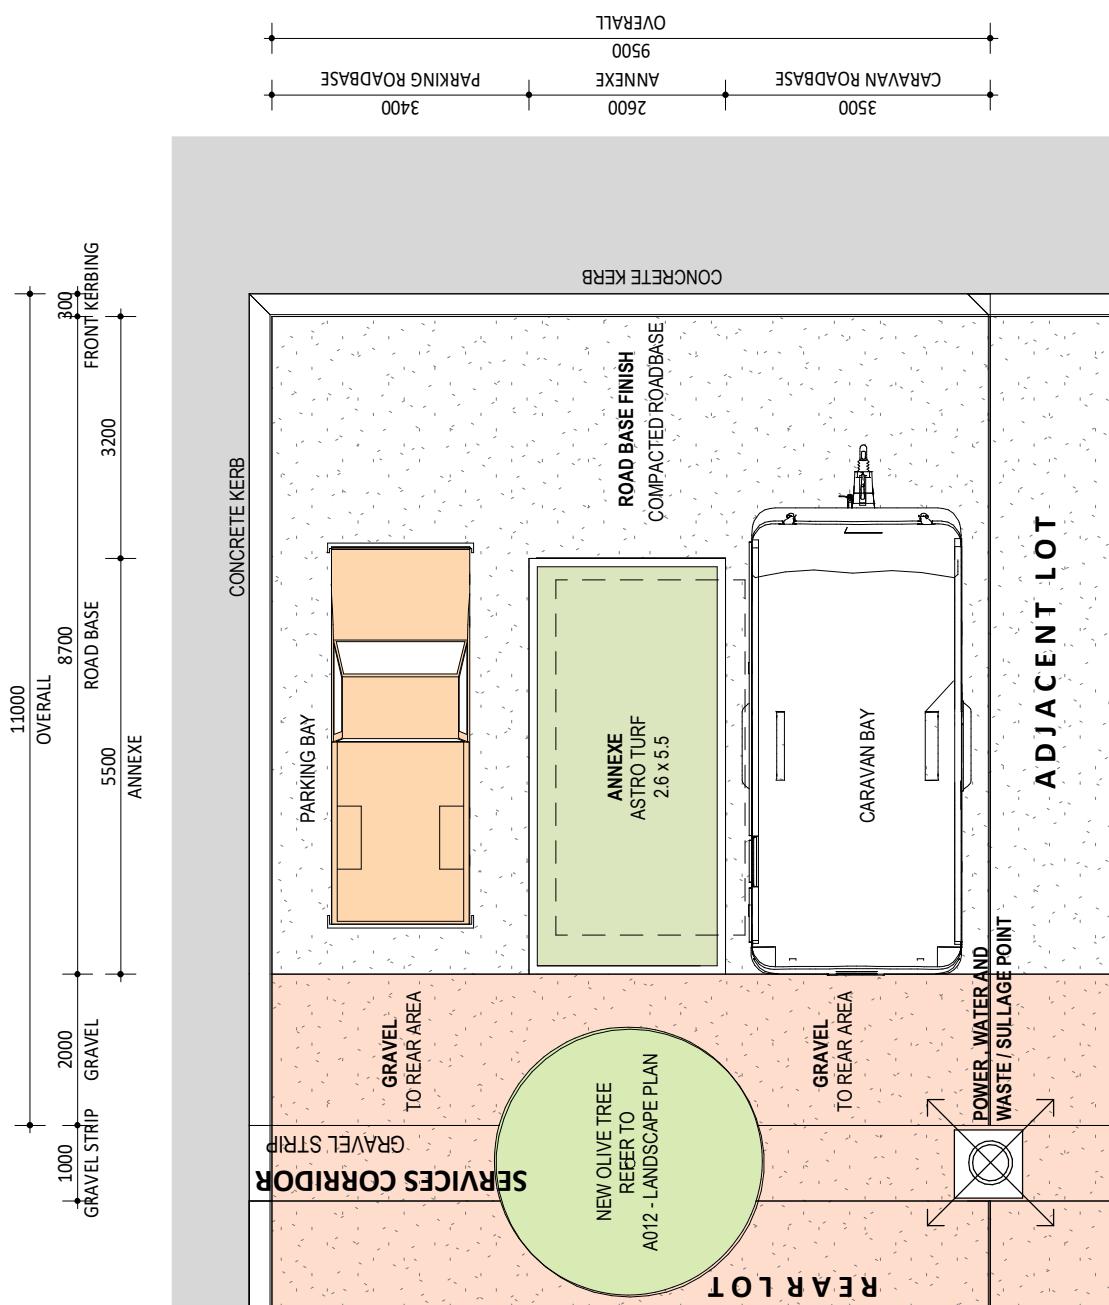

1 Typical Caravan Bay Layout - 11m x 9.5m

1 : 100


15 SITES ALLOCATED

2 Large Caravan Bay Layout - 12m x 9.5m

1 : 100

15 SITES ALLOCATED

GENERAL NOTES
 - ALL STRUCTURES TO MEET CYCLONIC REGION D, TERRAIN CATEGORY 1 REQUIREMENT.
 - ALL FINISHES THROUGHOUT TO BE SUITED TO THE HIGHLY CORROSIVE ONSLOW CLIMATE
 - ENTIRE FACILITY TO BE COMPLIANT AS PER AS1428

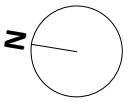

N

1:100 When Printed A3

0m 1m 3m 6m 10m

CONCRETE KERB

POWER, WATER AND
WASTE / SULLAGE POINT

GRAVEL
TO REAR AREA

ANNEXE
ASTRO TURF
2.6 x 5.5

CARAVAN BAY

ROAD BASE FINISH
COMPACTED ROADBASE

ROAD BASE
7200
OVERALL
9500

KERB
300
OVERALL
9500

PARKING ROADBASE
3500
OVERALL
9500

ANNEXE
2600
OVERALL
3400

CONCRETE KERB

POWER, WATER AND
WASTE / SULLAGE POINT

GRAVEL
TO REAR AREA

ANNEXE
ASTRO TURF
2.6 x 5.5

CARAVAN BAY

ROAD BASE FINISH
COMPACTED ROADBASE

ROAD BASE
7200
OVERALL
9500

KERB
300
OVERALL
9500

PARKING ROADBASE
3500
OVERALL
9500

ANNEXE
2000
OVERALL
11000

GRAVEL STRIP
1000

ANNEXE
5500

ROAD BASE
5500

KERB
2000

GRAVEL STRIP
2000

ANNEXE
4000

CARAVAN ROADBASE
4000

OVERALL
4600

ANNEXE
4000

CARAVAN ROAD BASE
4000

OVERALL
4600

PARKING ROAD BASE
3400

OVERALL
12000

ANNEXE
12000

CONCRETE KERB

POWER, WATER AND
WASTE / SULLAGE POINT

GRAVEL
TO REAR AREA

ANNEXE
ASTRO TURF
2.6 x 5.5

CARAVAN BAY

ROAD BASE FINISH
COMPACTED ROADBASE

ROAD BASE
7200
OVERALL
9500

KERB
300
OVERALL
9500

PARKING ROADBASE
3500
OVERALL
9500

ANNEXE
2600
OVERALL
3400

CONCRETE KERB

POWER, WATER AND
WASTE / SULLAGE POINT

GRAVEL
TO REAR AREA

ANNEXE
ASTRO TURF
2.6 x 5.5

CARAVAN BAY

ROAD BASE FINISH
COMPACTED ROADBASE

ROAD BASE
7200
OVERALL
9500

KERB
300
OVERALL
9500

PARKING ROADBASE
3500
OVERALL
9500

ANNEXE
2000
OVERALL
11000

GRAVEL STRIP
1000

ANNEXE
5500

ROAD BASE
5500

KERB
2000

GRAVEL STRIP
2000

ANNEXE
4000

CARAVAN ROAD BASE
4000

OVERALL
4600

ANNEXE
4000

PARKING ROAD BASE
3400

OVERALL
12000

ANNEXE
12000

CONCRETE KERB

POWER, WATER AND
WASTE / SULLAGE POINT

GRAVEL
TO REAR AREA

ANNEXE
ASTRO TURF
2.6 x 5.5

CARAVAN BAY

ROAD BASE FINISH
COMPACTED ROADBASE

ROAD BASE
7200
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KERB
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OVERALL
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PARKING ROADBASE
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OVERALL
9500

ANNEXE
2600
OVERALL
3400

CONCRETE KERB

POWER, WATER AND
WASTE / SULLAGE POINT

GRAVEL
TO REAR AREA

ANNEXE
ASTRO TURF
2.6 x 5.5

CARAVAN BAY

ROAD BASE FINISH
COMPACTED ROADBASE

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OVERALL
9500

KERB
300
OVERALL
9500

PARKING ROADBASE
3500
OVERALL
9500

ANNEXE
2000
OVERALL
11000

GRAVEL STRIP
1000

ANNEXE
5500

ROAD BASE
5500

KERB
2000

GRAVEL STRIP
2000

ANNEXE
4000

CARAVAN ROAD BASE
4000

OVERALL
4600

ANNEXE
4000

PARKING ROAD BASE
3400

OVERALL
12000

ANNEXE
12000

CONCRETE KERB

POWER, WATER AND
WASTE / SULLAGE POINT

GRAVEL
TO REAR AREA

ANNEXE
ASTRO TURF
2.6 x 5.5

CARAVAN BAY

ROAD BASE FINISH
COMPACTED ROADBASE

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KERB
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OVERALL
9500

PARKING ROADBASE
3500
OVERALL
9500

ANNEXE
2600
OVERALL
3400

CONCRETE KERB

POWER, WATER AND
WASTE / SULLAGE POINT

GRAVEL
TO REAR AREA

ANNEXE
ASTRO TURF
2.6 x 5.5

CARAVAN BAY

ROAD BASE FINISH
COMPACTED ROADBASE

ROAD BASE
7200
OVERALL
9500

KERB
300
OVERALL
9500

PARKING ROADBASE
3500
OVERALL
9500

ANNEXE
2000
OVERALL
11000

GRAVEL STRIP
1000

ANNEXE
5500

ROAD BASE
5500

KERB
2000

GRAVEL STRIP
2000

ANNEXE
4000

CARAVAN ROAD BASE
4000

OVERALL
4600

ANNEXE
4000

PARKING ROAD BASE
3400

OVERALL
12000

ANNEXE
12000

CONCRETE KERB

POWER, WATER AND
WASTE / SULLAGE POINT

GRAVEL
TO REAR AREA

ANNEXE
ASTRO TURF
2.6 x 5.5

CARAVAN BAY

ROAD BASE FINISH
COMPACTED ROADBASE

ROAD BASE
7200
OVERALL
9500

KERB
300
OVERALL
9500

PARKING ROADBASE
3500
OVERALL
9500

ANNEXE
2600
OVERALL
3400

CONCRETE KERB

POWER, WATER AND
WASTE / SULLAGE POINT

GRAVEL
TO REAR AREA

ANNEXE
ASTRO TURF
2.6 x 5.5



CARAVAN BAY

ROAD BASE FINISH
COMPACTED ROADBASE

ROAD BASE
7200
OVERALL
9500

KERB
300
OVERALL
9500

PARKING ROADBASE
3500
OVERALL
9500

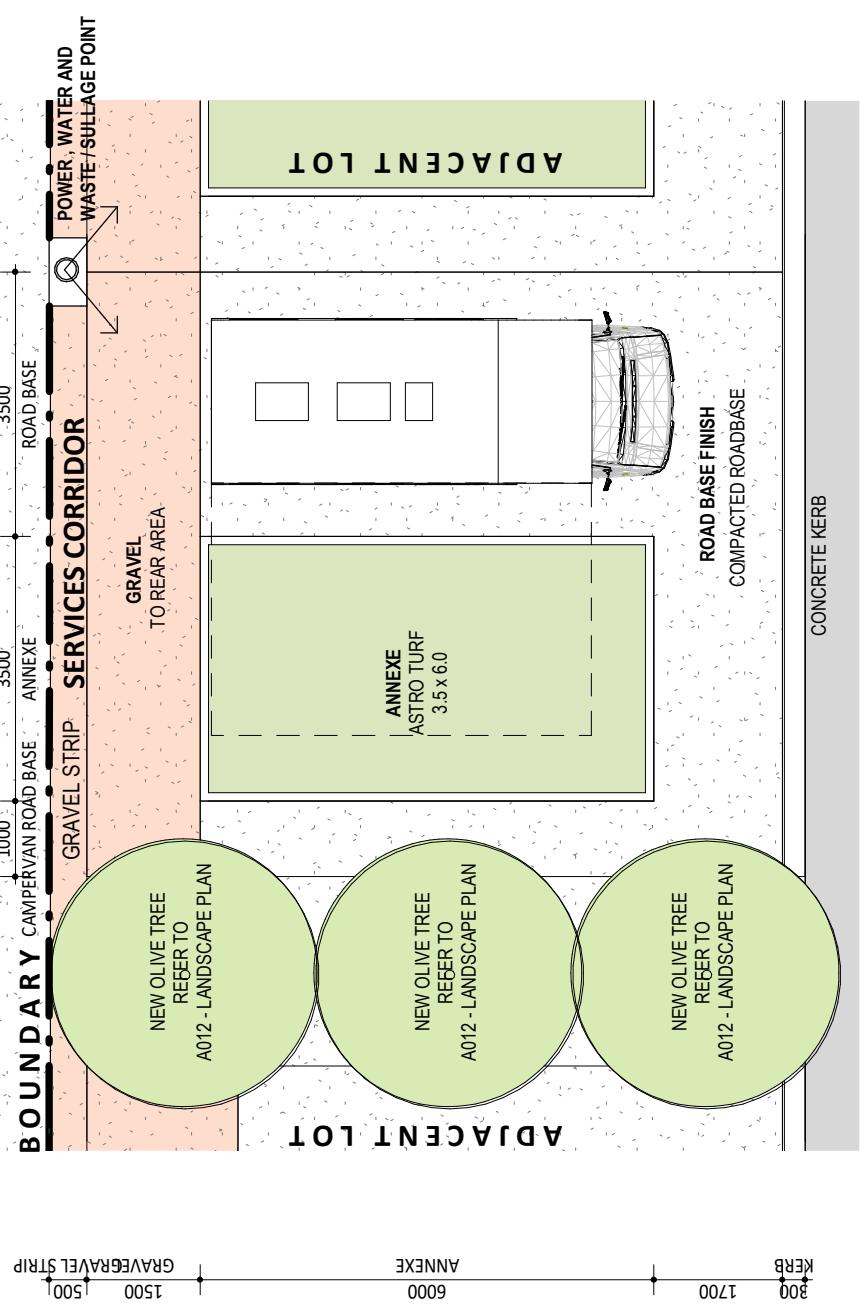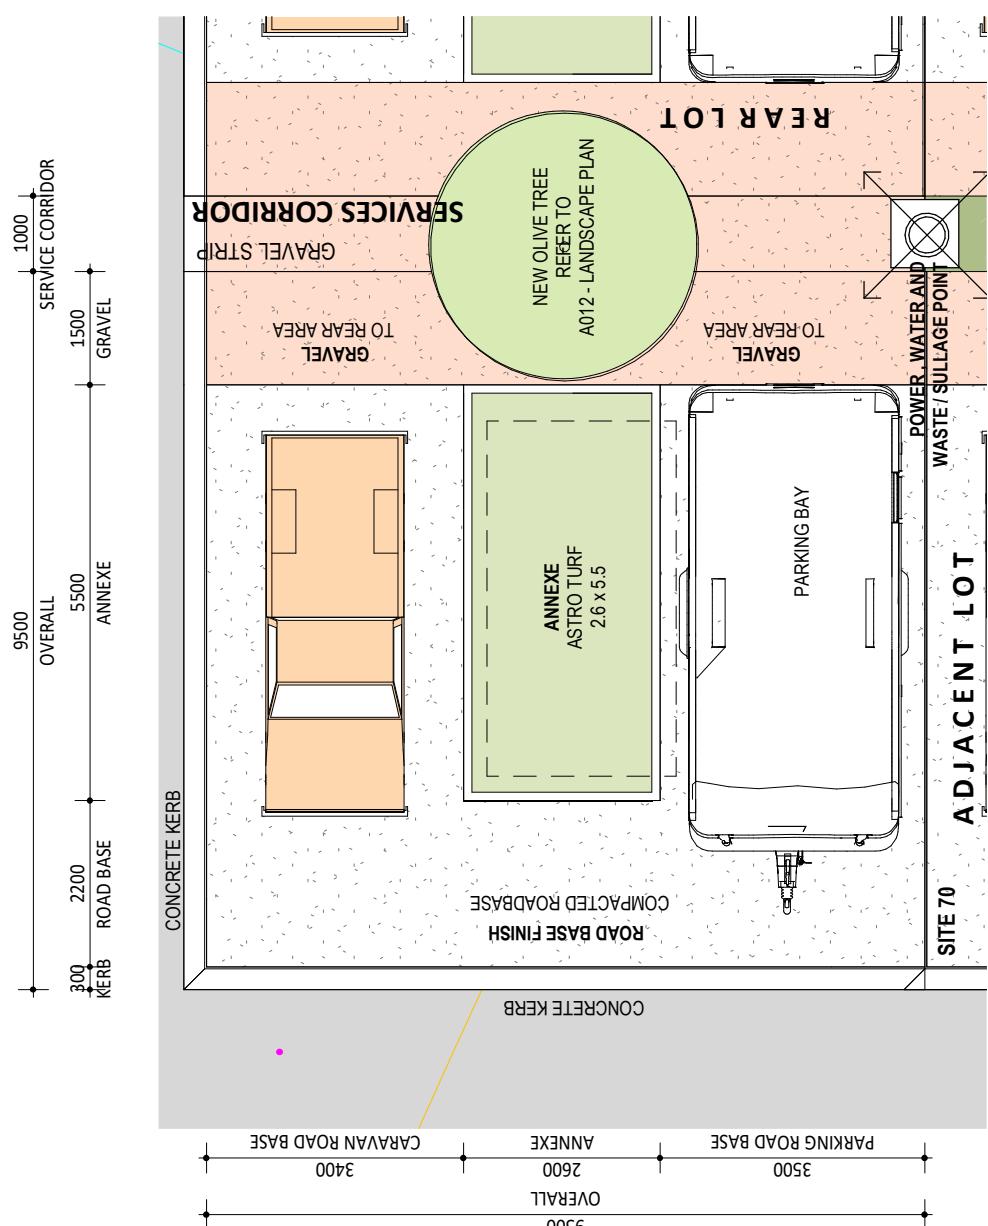

1 Small Caravan Bay Layout - 9.5m x 9.5m

1:100

4 SITES ALLOCATED


2 Camper-Van Bay Layout - 9.5m x 8m

1:100

10 SITES ALLOCATED

GENERAL NOTES

- ALL STRUCTURES TO MEET CYCLONIC REGION D, TERRAIN CATEGORY 1 REQUIREMENT
- ALL FINISHES THROUGHOUT TO BE SUITED TO THE HIGHLY CORROSIVE ONSLOW CLIMATE
- ENTIRE FACILITY TO BE COMPLIANT AS PER AS1428

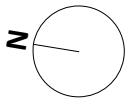

N

1:100 When Printed A3

0m 1m 3m 6m 10m

Project No. 21066 Drawn Author Approved Approver Scale @ A3: 1:100

Status **DEVELOPMENT APPROVAL** Rev

C

A510

Caravan Bays - Type 03 and 04

Project Onslow Caravan Park - Phase 3 Drawing title Drawing No Date

Shire of Ashburton feet to range Project Address

25/03/22 23/03/22 17/03/22

Lot 381 and 574, Onslow, WA 6710

Date

Description

Client

shire of Ashburton

feet to range

Project

Onslow Caravan Park - Phase 3

Drawing title

Drawing No

Rev

Approved

Approver

Scale @ A3: 1:100

For Development Approval

Revised for Development Approval

For Development Approval - Pre-submission Review

Description

For Development Approval - Pre-submission Review

Rev

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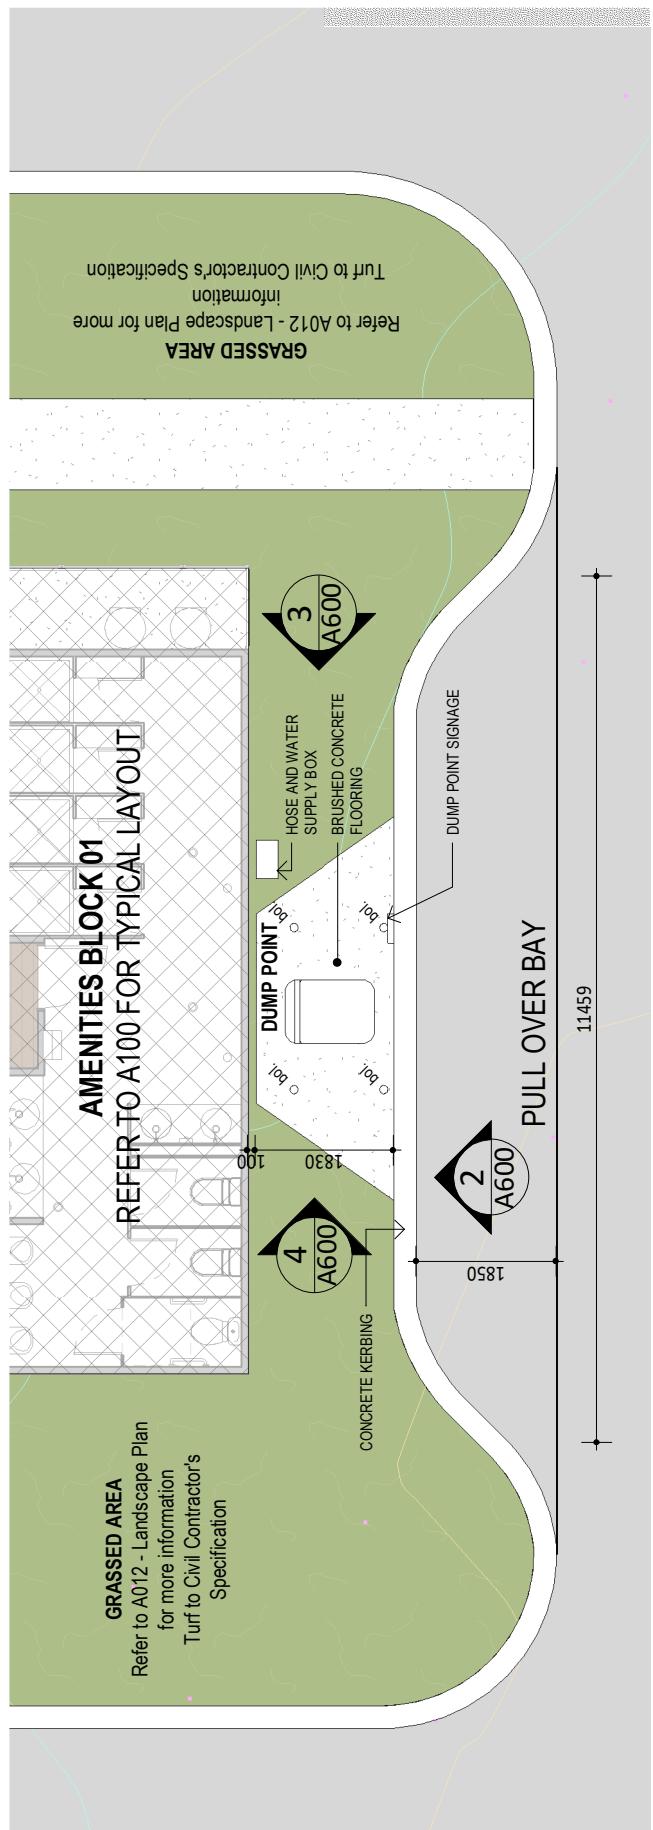
©

Whitehaus


architecture | interior design | drafting

2 Church Street PERTH 6000 | (08) 9226 3236


admin@whitehaus.com.au | ABN: 66 159 398 428




1 Dump Point - Layout
A001 1 : 100

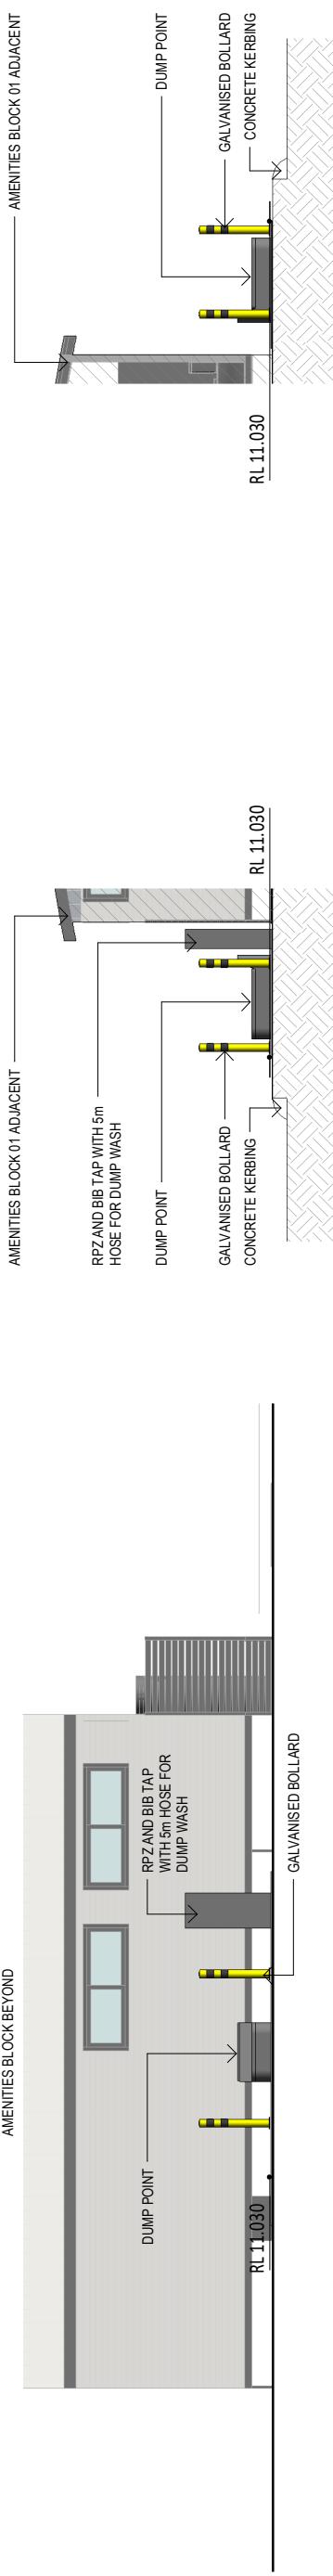

2 Dump Point - Southern Elevation
A001 1 : 100


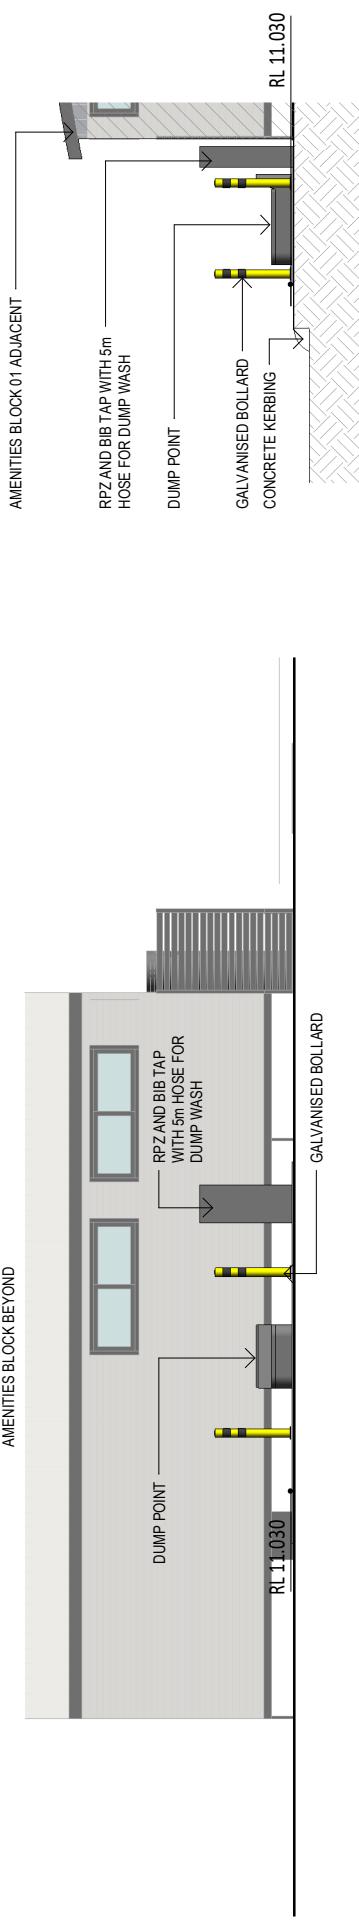


3 Dump Point - Eastern Elevation
A001 1 : 100

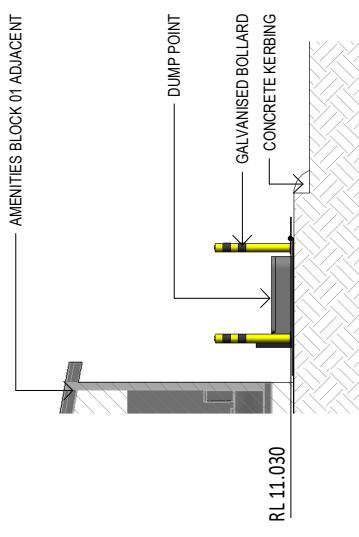

4 Dump Point - Western Elevation
A001 1 : 100

GENERAL NOTES
 - ALL STRUCTURES TO MEET CYCLONIC REGION D, TERRAIN CATEGORY 1 REQUIREMENTS.
 - ALL FINISHES THROUGHOUT TO BE SUITED TO THE HIGHLY CORROSIVE ONSLOW CLIMATE
 - ENTIRE FACILITY TO BE COMPLIANT AS PER AS1428

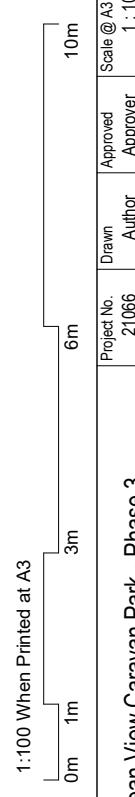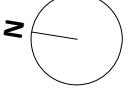

Dump Point Layout and Elevations



Project

Ocean View Caravan Park - Phase 3

Client

Shire of Ashburton

Reef to range

Drawing title

Dump Point Layout and Elevations

Date

23/03/22

Lot 381, Onslow, WA 6710

Project Address

25/03/22

For Development Approval

Rev

A

Revised for Development Approval

Rev

B

Development Approval

Rev

1:100


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architecture | interior design | drafting

2 Church Street PERTH 6000 | (08) 9226 3236

admin@whitehaus.com.au | ABN: 66 159 358 428



A) Check-In Kiosk - Layout

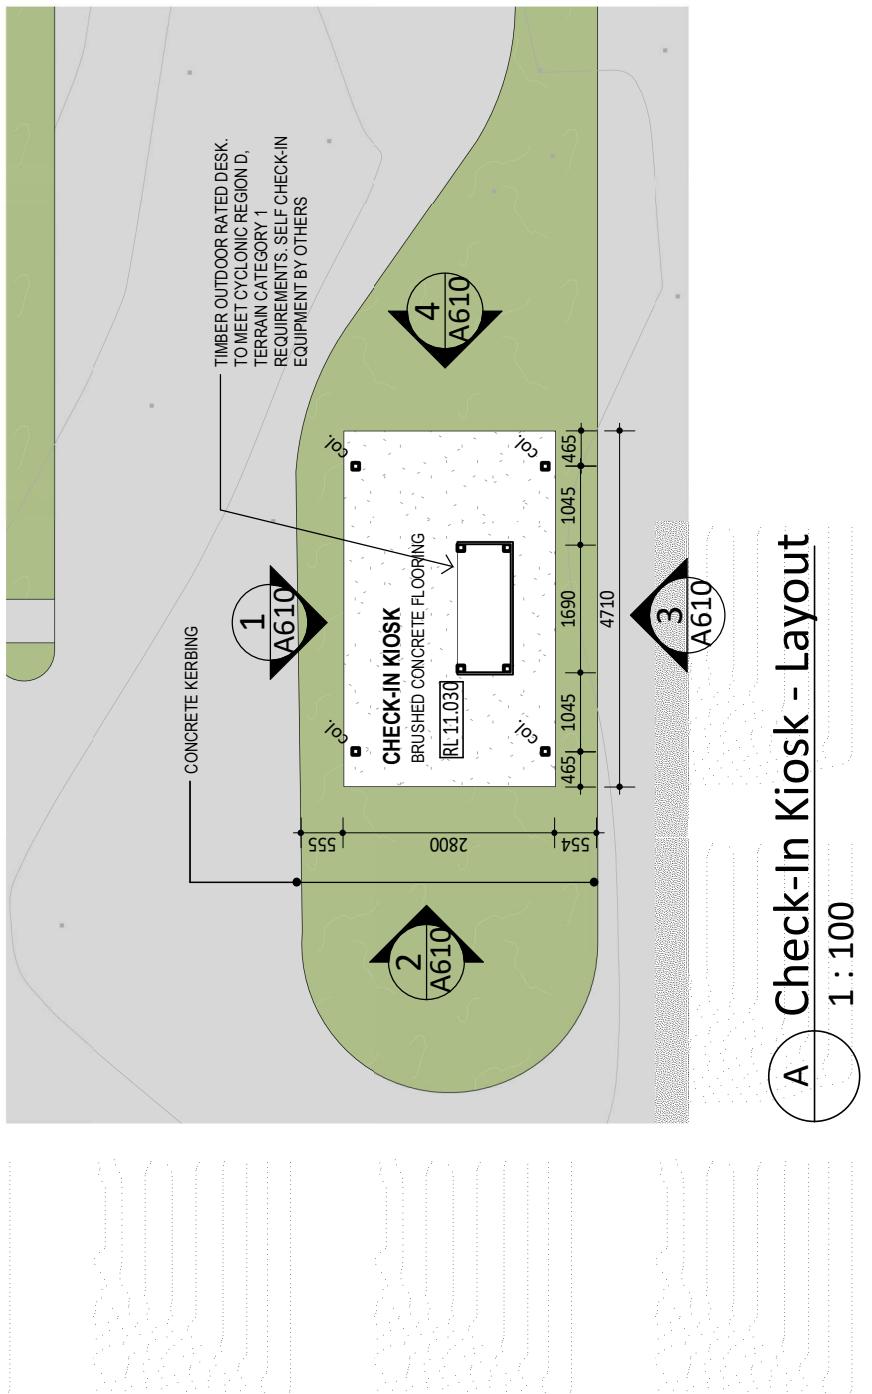The diagram illustrates a building's cross-section with specific dimensions and material specifications:

- RL 13.400:** NEW SURF MIST COLORBOND ROOF SHEETING TO POWDERCOATED COLUMNS AND ROOF STRUCTURE (EXTERIA OEA) - DEEP OCEAN
- RL 13.100:** GALVANISED AND PAINTED STEEL COLUMNS TO MATCH EXISTING PHASE 01 AND 02 COLOUR SCHEME
- RL 12.000:** TIMBER OUTDOOR RATED DESK. TO MEET CYCLONIC REGION D TERRAIN CATEGORY 1 REQUIREMENTS. SELF CHECK-IN EQUIPMENT BY OTHERS
- RL 11.030:** BRUSHED FINISHED CONCRETE SLAB
- RL 13.400:** GALVANISED AND PAINTED STEEL COLUMNS TO MATCH EXISTING PHASE 01 AND 02 COLOUR SCHEME
- RL 13.100:** TIMBER OUTDOOR RATED DESK. TO MEET CYCLONIC REGION D TERRAIN CATEGORY 1 REQUIREMENTS. SELF CHECK-IN EQUIPMENT BY OTHERS
- RL 11.030:** BRUSHED FINISHED CONCRETE SLAB

Kiosk - Northern Elevation
A610 1 : 100


Kiosk - Western Elevation
A610 1 : 100

Kiosk - Southern Elevation
A610 1 : 100

Kiosk - Eastern Elevation
A610 1 : 100

STRUCTURES - ALL STRUCTURES TO MEET CYCLONIC REGION D, TERRAIN CATEGORY 1 REQUIREMENT.
- ALL FINISHES THROUGHOUT TO BE SUITED TO THE HIGHLY CORROSIVE ONSLOW CLIMATE
- ENTIRE FACILITY TO BE COMPLIANT AS PER AS1428

| | |
|-----------------|------------|
| Client | shire of A |
| | |
| Project Address | Lot 138 |
| 03/22 | 03/22 |
| Date | |

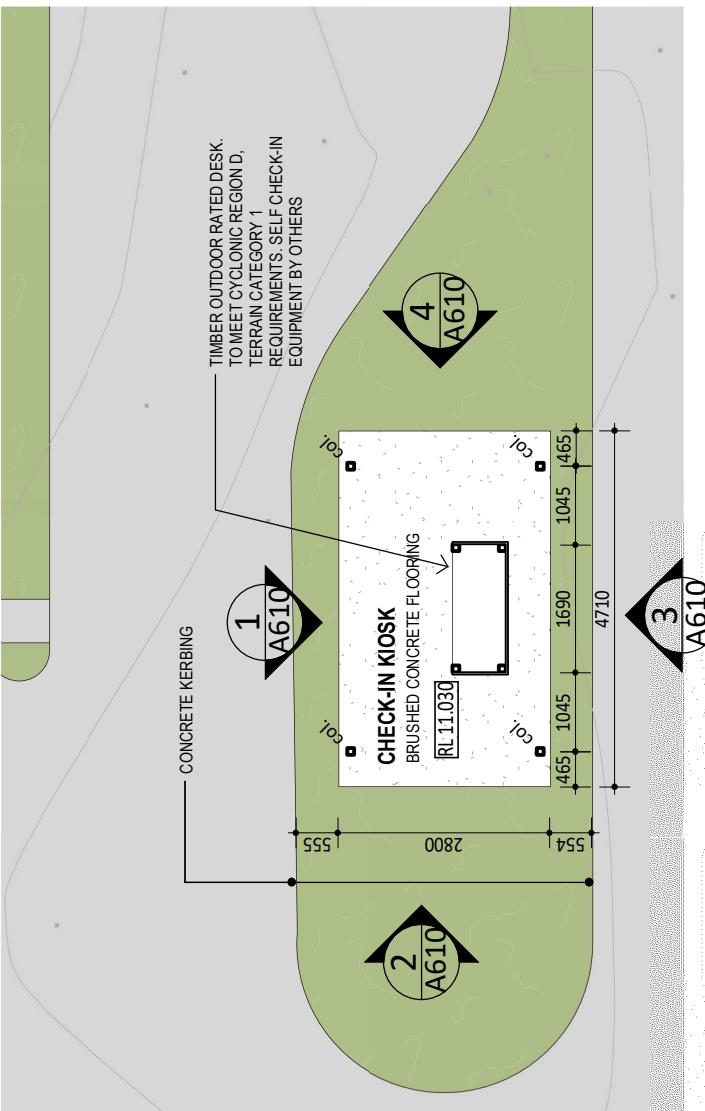

Check-In Kiosk - Roof Plan

1 : 100

The diagram illustrates a vertical cross-section of a building's exterior wall and roof. The wall features a grey concrete base slab at RL 11.030, followed by a white render layer and a grey render layer. Above these is a grey brick cavity wall. The roof consists of a grey concrete slab at RL 13.400, a white render layer, and a grey render layer. A grey metal fascia board runs along the top. Callouts provide specific details for different sections:


- Top Section:** 'NEW SURFACEMOUNT COLORBOND ROOF SHEETING TO POWDERCOATED COLUMNS AND ROOF STRUCTURE (EXTERIA OEA) - DEEP OCEAN' is shown above the roofline.
- Middle Section:** 'GALVANISED AND PAINTED STEEL COLUMNS TO MATCH EXISTING PHASE 01 AND 02 COLOUR SCHEME' is indicated for the columns.
- Right Section:** 'TIMBER OUTDOOR RATED DESK. MEET CYCLONIC REGION D, TERRAIN CATEGORY 1 REQUIREMENTS. SELF CHECK-IN EQUIPMENT BY OTHERS IN EQUIPMENT BY OTHERS' is described for a timber desk.
- Bottom Section:** 'BRUSHED FINISHED CONCRETE SLAB' is labeled for the concrete base slab.

C - Eastern Elevation

Ent
Drawing title

DWI WA 6710

| | | |
|-----------------|---------------------------|--------------|
| Client | Shire of Ashburton | ref to range |
| Project Address | Lot 381 and 574, Onsl | |

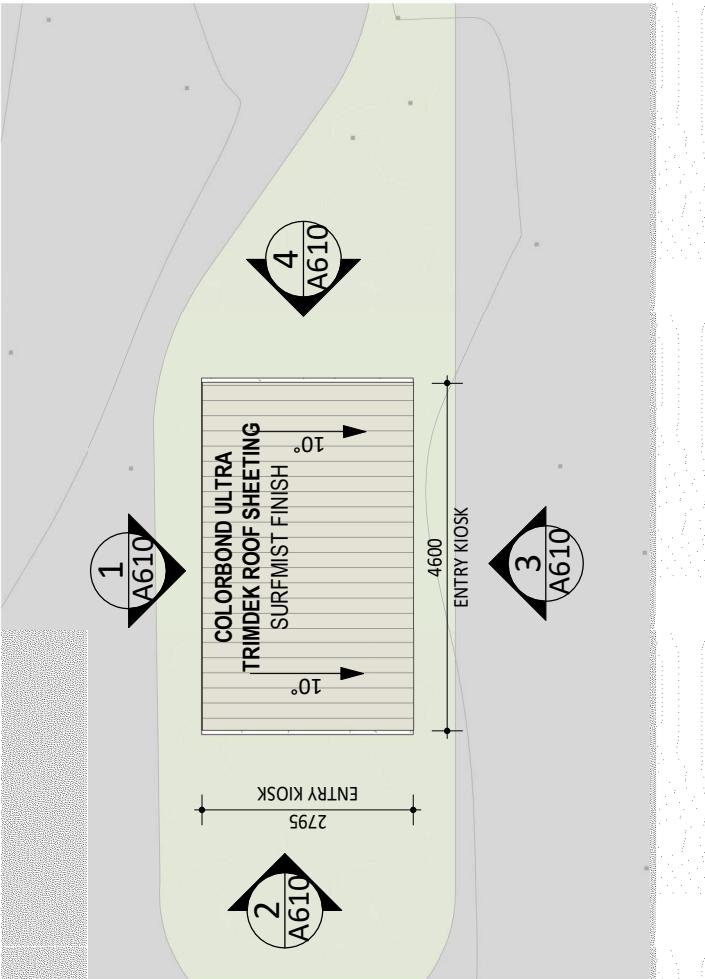

k - Roof Plan

Cost Plan Summary

Project: Ashburton

Details: OVCP Stage 3 (Phase 1) 20-04-2022

Building: Ocean View Caravan Park Onslow – Stage
3

| Code | Description | Quantity | Unit | Rate | Total |
|------|---|----------|------|------|-----------|
| 1 | NOTES & EXCLUSIONS | | | | 0 |
| 2 | SITEWORKS – WITHIN SITE | | | | 1,092,000 |
| 3 | SITEWORKS – OUTSIDE SITE | | | | 66,000 |
| 4 | ROADS, PAVING & DRAINAGE – WITHIN SITE | | | | 1,124,000 |
| 5 | ROADS, PAVING & DRAINAGE – OUTSIDE SITE | | | | 236,000 |
| 6 | BUILDINGS & STRUCTURES – AMENITIES | | | | 1,615,000 |
| 7 | CHALETS – Excluded | | | | 0 |
| 8 | RV BAYS | | | | 606,500 |
| 9 | SERVICES – WITHIN SITE | | | | 721,000 |
| 10 | SERVICES – OUTSIDE SITE | | | | 490,000 |
| 11 | MISCELLANEOUS | | | | 111,000 |
| 12 | PRELIMINARIES | | | | 1,100,000 |
| | | | | | |
| | Sub-Total | | | | 7,161,500 |
| | | | | | |
| 13 | Design Contingency | 5.0 | % | | 359,000 |
| 14 | Construction Contingency | 5.0 | % | | 359,000 |
| 15 | Professional Fees & Travel Disbursements | 6.7 | % | | 504,000 |
| 16 | Cost escalation allowance assuming construction commencing October 2022 | | Item | | 205,000 |
| | | | | | |
| | Total Excluding GST | | | | 8,588,500 |

Cost Plan

Project: Ashburton

Details: OVCP Stage 3 (Phase 1) 20-04-2022

Building: Ocean View Caravan Park Onslow – Stage
3

| Code | Description | Quantity | Unit | Rate | Total |
|------|-------------|----------|------|------|-------|
|------|-------------|----------|------|------|-------|

NOTES & EXCLUSIONS

| | Notes | | | | |
|----|--|--|--|--|--|
| 1 | No Structural, Civil (except preliminary roadworks - Second Ave) or Services design was available at the time of preparing this estimate | | | | |
| 2 | This cost indication is based on conceptual design information provided by the Development Manager. The information provided is preliminary and incomplete. Accordingly, this cost indication reflects the current conceptual design information and may vary significantly once investigation work and designs are finalised. | | | | |
| 3 | By their nature, these estimates and assumptions are subject to significant uncertainties and, accordingly, the actual costs may materially differ from these estimates and assumptions. Accordingly, no assurance can be given that the cost estimates and the underlying assumptions will be realised in practice | | | | |
| 4 | Pricing assumes the project will be competitively tendered | | | | |
| | Exclusions | | | | |
| 5 | Rock excavation | | | | |
| 6 | De-watering | | | | |
| 7 | Sewer pump station | | | | |
| 8 | Gas service | | | | |
| 9 | Parking areas & loop road outside the site boundary (except overflow parking shown behind chalet 1) | | | | |
| | Reference Documents | | | | |
| 10 | This preliminary cost indication has been based on the following documents prepared by Whitehaus: | | | | |
| 11 | Phase 1 Masterplan A005 Rev F scale 1:1500 | | | | |
| 12 | Final Phase Masterplan A010 Rev F scale 1:1500 | | | | |
| 13 | Development Approval Set dated 25/03/2022 – 16 sheets | | | | |
| 14 | Civil drawings prepared by Edgeloe Engineering: | | | | |
| 15 | Earthworks Plan – Second Ave 101 Rev A Dated 13/04/2022 | | | | |
| 16 | Roadworks Plan – Second Ave 301 Rev A Dated 13/04/2022 | | | | |
| 17 | Roadworks cross sections – Second Ave 401 Rev A Dated 13/04/2022 | | | | |

NOTES & EXCLUSIONS

0

SITEWORKS – WITHIN SITE

| | | | | | |
|----|---|--------|----|----------|---------|
| 18 | Clear the site of vegetation, pavement, kerbing, drainage structures and remove topsoil | 24,000 | m2 | 3.00 | 72,000 |
| 19 | Bulk earthworks – cut to fill to achieve design levels | 13,000 | m3 | 18.00 | 234,000 |
| 20 | Imported fill | 12,000 | m3 | 30.00 | 360,000 |
| 21 | Retaining wall 1.2m high behind chalets (twinwall or similar as per Stage 2 details) | 120 | m | 2,050.00 | 246,000 |
| 22 | Landscaping & reticulation | | PS | | 180,000 |

SITEWORKS – WITHIN SITE

1,092,000

Cost Plan

Project: Ashburton

Details: OVCP Stage 3 (Phase 1) 20-04-2022

Building: Ocean View Caravan Park Onslow – Stage
3

| Code | Description | Quantity | Unit | Rate | Total |
|--|--|----------|------|-----------|-----------|
| SITEWORKS – OUTSIDE SITE | | | | | |
| 23 | Clear site for new roadworks & parking outside the site boundary | 1,300 | m2 | 3.00 | 3,900 |
| 24 | Bulk earthworks – cut to fill & compact to achieve design levels – roadworks & parking outside site boundary (BCM) | 430 | m3 | 60.00 | 25,800 |
| 25 | Cut to spoil – spread & level outside road reserve (bulked qty) | 1,065 | m3 | 30.00 | 31,950 |
| 26 | Traffic management | | Item | | 4,350 |
| SITEWORKS – OUTSIDE SITE | | | | | |
| 66,000 | | | | | |
| ROADS, PAVING & DRAINAGE – WITHIN SITE | | | | | |
| 27 | New internal access roads – 30mm Asphalt on 200 thick roadbase | 7,350 | m2 | 120.00 | 882,000 |
| 28 | Mountable kerb or flush concrete edge beam | 1,950 | m | 90.00 | 175,500 |
| 29 | Soakwells within road system | | Item | | 40,500 |
| 30 | Pedestrian paving | 200 | m2 | 130.00 | 26,000 |
| ROADS, PAVING & DRAINAGE – WITHIN SITE | | | | | |
| 1,124,000 | | | | | |
| ROADS, PAVING & DRAINAGE – OUTSIDE SITE | | | | | |
| 31 | Extend main access road including drop off zone bays & drainage – Second Avenue. 300mm Road base only – no seal or kerbs | 1,460 | m2 | 100.00 | 146,000 |
| 32 | Raised Modwood (or similar) walkway and connect to existing including modifications to existing as necessary | 60 | m | 1,500.00 | 90,000 |
| ROADS, PAVING & DRAINAGE – OUTSIDE SITE | | | | | |
| 236,000 | | | | | |
| BUILDINGS & STRUCTURES – AMENITIES | | | | | |
| | Buildings – traditional construction on site | | | | |
| 33 | Check-in kiosk (unmanned) | 1 | No | 40,000 | 40,000 |
| 34 | New Amenities Building including ramps, decking & steps | 2 | No | 606,500 | 1,213,000 |
| 35 | Solar hot water systems – Amenities | 2 | Item | 30,000 | 60,000 |
| 36 | Fence to drying areas – Amenities | 20 | m | 400 | 8,000 |
| 37 | Pavement to drying enclosure | 40 | m2 | 200.00 | 8,000 |
| 38 | Screen to services enclosure | 22 | m | 500 | 11,000 |
| 39 | Clothes lines | 6 | No | 5,000 | 30,000 |
| 40 | BBQ Shelter, table, chairs, shade sails & BBQ's | 1 | No | 100,000 | 100,000 |
| 41 | Children's playground & equipment | | Item | | 50,000 |
| 42 | Bin enclosure | 1 | No | 15,000 | 15,000 |
| 43 | Fish cleaning station | 1 | No | 70,000 | 70,000 |
| 44 | Gas bullet hardstand | 1 | No | 10,000.00 | 10,000 |
| BUILDINGS & STRUCTURES – AMENITIES | | | | | |
| 1,615,000 | | | | | |
| RV BAYS | | | | | |
| 45 | Road base hardstand (100 thick) | 9,055 | m2 | 40.00 | 362,200 |
| 46 | Annexe pad – 100 thick crushed rock pad with Astro Turf | 1,445 | m2 | 140.00 | 202,300 |
| 47 | 100 x 50 timber surround to annexe pad | 1,680 | m | 25.00 | 42,000 |

Cost Plan

Project: Ashburton
Building: Ocean View Caravan Park Onslow – Stage 3

Details: OVCP Stage 3 (Phase 1) 20-04-2022

| Code | Description | Quantity | Unit | Rate | Total |
|--------------------------------|---|----------|------|------------|----------------|
| RV BAYS | | | | | (Continued) |
| RV BAYS | | | | | 606,500 |
| SERVICES – WITHIN SITE | | | | | |
| | Water | | | | |
| 48 | New pump | | Item | | 40,000 |
| 49 | Water tanks | | Item | | 60,000 |
| 50 | Water pipework reticulation within new caravan park site | | Item | | 44,000 |
| 51 | Connect to Kmac pillar | 39 | No | 250.00 | 9,750 |
| | Fire | | | | |
| 52 | Fire extinguisher & housing | 25 | No | 800.00 | 20,000 |
| | Sewer | | | | |
| 53 | Sewer pipework reticulation within new caravan park site | | Item | | 84,000 |
| 54 | Sullage dump point | | Item | | 10,000 |
| | Miscellaneous | | | | |
| 55 | Backflow prevention | | Item | | 4,000 |
| 56 | Testing & Commissioning | | Item | | 1,280 |
| | Electrical | | | | |
| 57 | Electrical services including access control & CCTV | | Item | | 400,000 |
| 58 | Allowance for bollard or similar lighting within caravan park areas | | Item | | 40,000 |
| | Builder's Work | | | | |
| 59 | Allowance for builder's works in connection with services works | | Item | | 7,970 |
| SERVICES – WITHIN SITE | | | | | 721,000 |
| SERVICES – OUTSIDE SITE | | | | | |
| 60 | Horizon Power | 1 | Item | 130,715.00 | 130,715 |
| 61 | Sewer | 1 | Item | 138,282.00 | 138,282 |
| 62 | Water | 1 | Item | 48,496.00 | 48,496 |
| 63 | Wastewater infrastructure contribution | 1 | Item | 167,450.00 | 167,450 |
| 64 | Telecom | 1 | Item | 5,057.00 | 5,057 |
| SERVICES – OUTSIDE SITE | | | | | 490,000 |
| MISCELLANEOUS | | | | | |
| 65 | Cable or boom gates | | Item | | 15,000 |
| 66 | Screen to exit lane 2200 high | 45 | m | 500.00 | 22,500 |
| 67 | Cyclone mesh fencing 1800 high | 120 | m | 150.00 | 18,000 |
| 68 | Garrison fencing to overflow carpark | 70 | m | 600.00 | 42,000 |
| 69 | Double gate to last | 1 | No | 3,000.00 | 3,000 |

Cost Plan

Project: Ashburton

Details: OVCP Stage 3 (Phase 1) 20-04-2022

Building: Ocean View Caravan Park Onslow – Stage
3

| Code | Description | Quantity | Unit | Rate | Total |
|----------------------|---|----------|------|------|-----------|
| MISCELLANEOUS | | | | | |
| 70 | Signage | | Item | | 10,500 |
| MISCELLANEOUS | | | | | |
| PRELIMINARIES | | | | | |
| 71 | Preliminaries & General costs including but not limited to: | | Item | | 1,100,000 |
| 72 | Mobilisation | | | | |
| 73 | Fees, levees, insurances | | | | |
| 74 | Site facilities & running costs | | | | |
| 75 | Management plans | | | | |
| 76 | Supervision & management | | | | |
| 77 | Traffic management | | | | |
| 78 | Survey | | | | |
| 79 | Consumables | | | | |
| 80 | Demobilisation | | | | |
| 81 | Contractor margin | | | | |
| PRELIMINARIES | | | | | |
| 1,100,000 | | | | | |
| <i>(Continued)</i> | | | | | |

| Ocean View Caravan Park | | 2021 | 2022 | 2023 | 2024 | 2025 | 2026 | 2027 | 2028 | 2029 | 2030 | 2031 | 2032 |
|-----------------------------|------------------|------------------|------------------|------------------|------------------|------------------|------------------|------------------|------------------|------------------|------------------|------------------|--------------------|
| Forecast Profit and Loss | Actual | Actual YTD | Forecast |
| Revenue | | | | | | | | | | | | | |
| Cabins | 178,000 | 139,300 | 178,300 | 180,000 | 180,000 | 180,000 | 180,000 | 180,000 | 180,000 | 180,000 | 180,000 | 180,000 | 180,000 |
| Laundry Fees | 11,800 | 10,200 | 13,200 | 20,000 | 25,000 | 25,400 | 25,600 | 25,800 | 26,000 | 26,200 | 26,400 | 26,600 | 26,600 |
| Other Sales | 4,900 | 7,500 | 9,000 | 12,500 | 15,000 | 15,100 | 15,200 | 15,300 | 15,400 | 15,500 | 15,600 | 15,700 | 15,800 |
| Overflow Sites | 6,100 | 23,600 | 12,500 | 0 | 0 | 0 | 0 | 0 | 0 | 0 | 0 | 0 | 0 |
| Powered Sites | 508,200 | 571,400 | 800,000 | 1,100,000 | 1,111,000 | 1,122,100 | 1,133,300 | 1,144,600 | 1,156,000 | 1,167,500 | 1,179,100 | 1,190,800 | 1,190,800 |
| Unpowered Sites | 26,300 | 12,200 | 15,200 | 15,000 | 20,000 | 20,200 | 20,400 | 20,600 | 20,800 | 21,000 | 21,200 | 21,400 | 21,600 |
| Total Revenue | 735,300 | 584,200 | 812,700 | 1,040,000 | 1,340,000 | 1,351,500 | 1,363,100 | 1,374,800 | 1,386,600 | 1,398,500 | 1,410,500 | 1,422,600 | 1,434,800 |
| Expense | | | | | | | | | | | | | |
| Employee Costs | (435,100) | (267,400) | (325,400) | (400,000) | (450,000) | (459,000) | (468,100) | (477,400) | (486,900) | (496,600) | (506,500) | (516,600) | (526,900) |
| Insurance | (20,800) | (44,600) | (44,600) | (45,000) | (60,000) | (61,200) | (62,400) | (63,600) | (64,800) | (66,000) | (67,300) | (68,600) | (69,900) |
| Motor Vehicle | (7,800) | (1,400) | (3,900) | (5,000) | (5,100) | (5,200) | (5,300) | (5,400) | (5,500) | (5,600) | (5,700) | (5,800) | (5,800) |
| Operations - General | (32,000) | (19,400) | (24,400) | (30,000) | (40,000) | (40,800) | (41,600) | (42,400) | (43,200) | (44,000) | (44,800) | (45,600) | (46,500) |
| Repairs and Replacement | (21,400) | (26,000) | (34,000) | (40,000) | (50,000) | (51,000) | (52,000) | (53,000) | (54,000) | (55,000) | (56,100) | (57,200) | (58,300) |
| Utilities | (228,800) | (88,200) | (108,200) | (150,000) | (200,000) | (204,000) | (208,000) | (212,100) | (216,300) | (220,600) | (225,000) | (229,500) | (234,000) |
| Waste Collection | (38,800) | 0 | (40,000) | (50,000) | (60,000) | (61,200) | (62,400) | (63,600) | (64,800) | (66,000) | (67,300) | (68,600) | (69,900) |
| Total Expense | (784,700) | (447,000) | (580,500) | (720,000) | (865,000) | (882,300) | (899,700) | (917,400) | (935,400) | (953,700) | (972,600) | (991,800) | (1,011,300) |
| Cash Profit / (Loss) | (49,400) | 137,200 | 232,200 | 320,000 | 475,000 | 469,200 | 463,400 | 457,400 | 451,200 | 444,800 | 437,900 | 430,800 | 423,500 |
| Depreciation | (240,000) | (180,000) | (240,000) | (320,000) | (320,000) | (320,000) | (320,000) | (320,000) | (320,000) | (320,000) | (320,000) | (320,000) | (320,000) |
| Net Profit / (Loss) | (289,400) | (42,800) | (7,800) | 0 | 155,000 | 149,200 | 143,400 | 137,400 | 131,200 | 124,800 | 117,900 | 110,800 | 103,500 |


Assume revenue increase (per annum) of . 1.0%

Assume expense increase (per annum) of . 2.0%

Assume Funding from Reserves

Assume full doubling of Powered Sites by 2023-2024

Assume removal of all Overflow Sites in 2022-2023

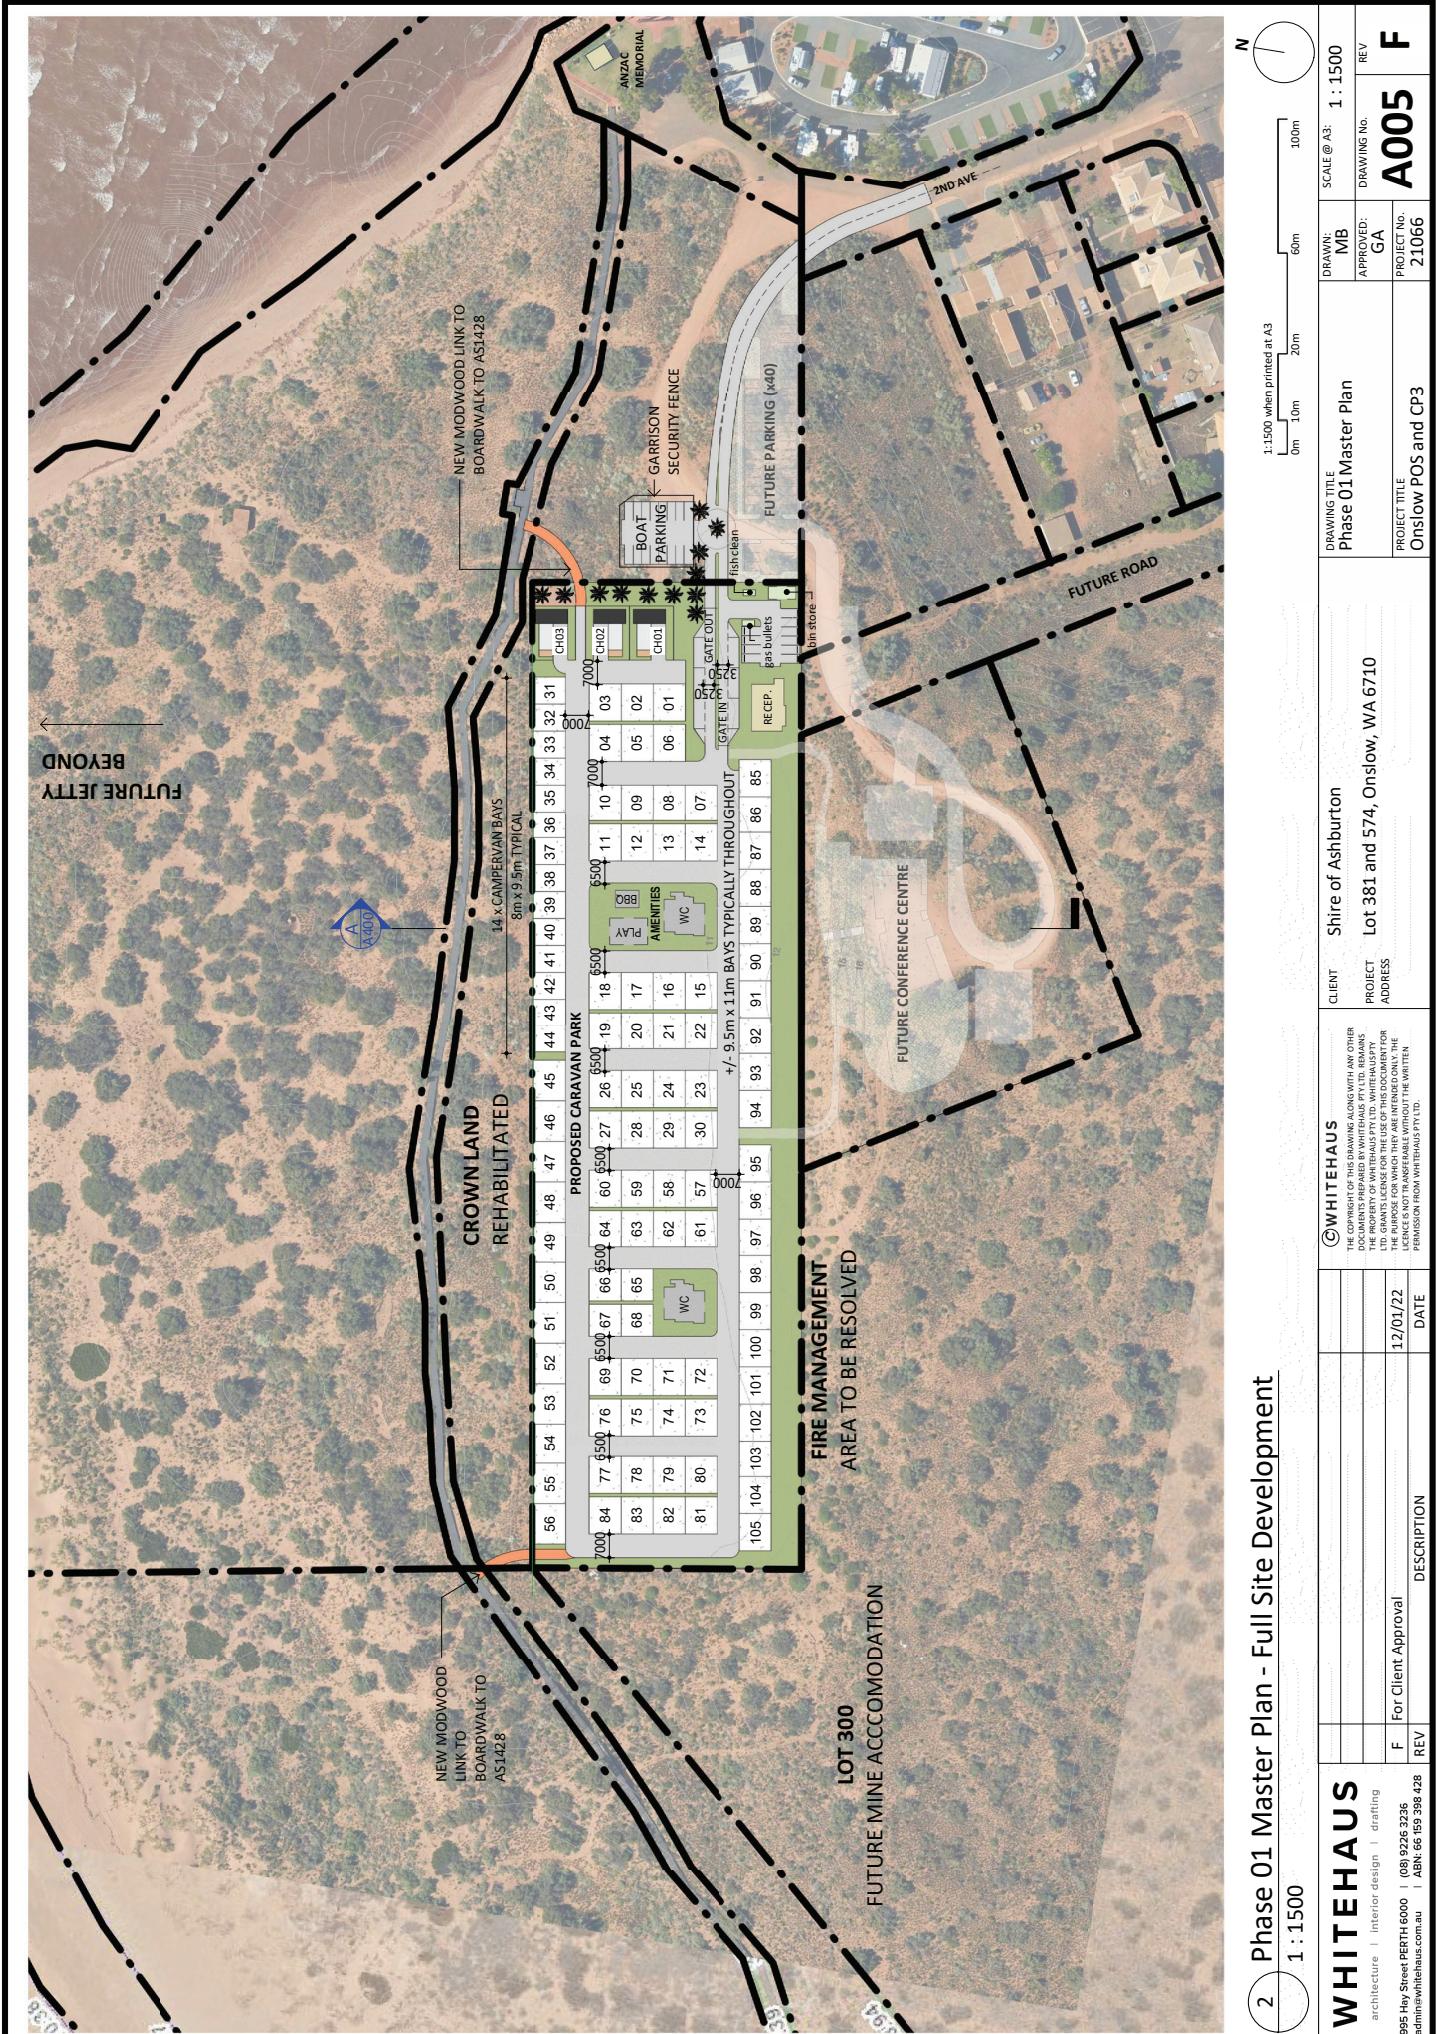

Cost Plan Summary

Project: Ashburton

Details: OVCP Stage 3 (Phase 1) 17-01-2022

Building: Ocean View Caravan Park Onslow – Stage
3

| Code | Description | Quantity | Unit | Rate | Total |
|------|---|-------------|------|------|------------|
| 1 | NOTES & EXCLUSIONS | | | | 0 |
| 2 | SITEWORKS – WITHIN SITE | | | | 1,158,000 |
| 3 | SITEWORKS – OUTSIDE SITE | | | | 13,950 |
| 4 | ROADS, PAVING & DRAINAGE – WITHIN SITE | | | | 1,119,500 |
| 5 | ROADS, PAVING & DRAINAGE – OUTSIDE SITE | | | | 438,500 |
| 6 | BUILDINGS & STRUCTURES – AMENITIES | | | | 1,979,400 |
| 7 | CHALETS | | | | 1,083,000 |
| 8 | RV BAYS | | | | 606,500 |
| 9 | SERVICES – WITHIN SITE | | | | 721,000 |
| 10 | SERVICES – OUTSIDE SITE | | | | 202,000 |
| 11 | MISCELLANEOUS | | | | 336,500 |
| 12 | PRELIMINARIES | | | | 1,150,000 |
| | | | | | |
| | Sub-Total | | | | 8,808,350 |
| | | | | | |
| 13 | Design Contingency | 5 | % | | 441,000 |
| 14 | Construction Contingency | 5 | % | | 441,000 |
| 15 | Professional Fees & Travel Disbursements | 7.5 | % | | 694,000 |
| 16 | Cost escalation allowance assuming construction commencing October 2022 | | Item | | 605,000 |
| | | | | | |
| | Total Excluding GST | | | | 10,989,350 |
| | | | | | |
| | | | | | |
| | SUMMARY ALL-IN COSTS | | | | |
| | | | | | |
| 17 | STAGE 3 CARAVAN PARK WORKS | \$8,496,598 | | | |
| 18 | WORKS OUTSIDE SITE BOUNDARY | \$937,279 | | | |
| 19 | CHALETS | \$1,555,472 | | | |

Cost Plan

Project: Ashburton

Details: OVCP Stage 3 (Phase 1) 17-01-2022

Building: Ocean View Caravan Park Onslow – Stage
3

| Code | Description | Quantity | Unit | Rate | Total |
|------|-------------|----------|------|------|-------|
|------|-------------|----------|------|------|-------|

NOTES & EXCLUSIONS

| | | | | | |
|----|--|--|--|--|--|
| | Notes | | | | |
| 1 | No Structural, Civil or Services design was available at the time of preparing this estimate | | | | |
| 2 | This cost indication is based on conceptual design information provided by the Development Manager. The information provided is preliminary and incomplete. Accordingly, this cost indication reflects the current conceptual design information and may vary significantly once investigation work and designs are finalised. | | | | |
| 3 | By their nature, these estimates and assumptions are subject to significant uncertainties and, accordingly, the actual costs may materially differ from these estimates and assumptions. Accordingly, no assurance can be given that the cost estimates and the underlying assumptions will be realised in practice | | | | |
| 4 | Pricing assumes the project will be competitively tendered | | | | |
| | Exclusions | | | | |
| 5 | Rock excavation | | | | |
| 6 | De-watering | | | | |
| 7 | Sewer pump station | | | | |
| 8 | Gas service | | | | |
| 9 | Parking areas & loop road outside the site boundary (except overflow parking shown behind chalet 1) | | | | |
| | Reference Documents | | | | |
| 10 | This preliminary cost indication has been based on the following documents prepared by Whitehaus: | | | | |
| 11 | Phase 1 Masterplan A005 Rev F scale 1:1500 | | | | |
| 12 | Final Phase Masterplan A010 Rev F scale 1:1500 | | | | |
| 13 | Building Plan (Typical Amenities Block & Reception Laundry) A110 Rev C scale 1:100 | | | | |
| 14 | Typical Chalet Plans (Ground Floor & Level One) A111 Rev B scale 1:100 | | | | |
| 15 | Dump Point & Fish Clean Plan A130 Rev C scale 1:100 | | | | |
| 16 | BBQ Area Plan A140 Rev C scale 1:100 | | | | |
| 17 | Bins Area Plan A160 Rev C scale 1:50 | | | | |
| 18 | Diagrammatic Site Sections (A & B) A400 Rev C scale 1:500 | | | | |

NOTES & EXCLUSIONS

0

SITEWORKS - WITHIN SITE

| | | | | | |
|----|---|--------|----|----------|---------|
| 19 | Clear the site of vegetation, pavement, kerbing, drainage structures and remove topsoil | 24,000 | m2 | 3.00 | 72,000 |
| 20 | Bulk earthworks – cut to fill to achieve design levels | 13,000 | m3 | 18.00 | 234,000 |
| 21 | Imported fill | 12,000 | m3 | 26.00 | 312,000 |
| 22 | Retaining wall 2.5m high behind chalets | 300 | m | 1,200.00 | 360,000 |
| 23 | Landscaping & reticulation | | PS | | 180,000 |

Cost Plan

Project: Ashburton

Details: OVCP Stage 3 (Phase 1) 17-01-2022

Building: Ocean View Caravan Park Onslow – Stage
3

| Code | Description | Quantity | Unit | Rate | Total |
|--|---|----------|------|----------|-----------|
| SITEWORKS – WITHIN SITE | | | | | |
| <i>(Continued)</i> | | | | | |
| SITEWORKS – WITHIN SITE | | | | | |
| 1,158,000 | | | | | |
| SITEWORKS – OUTSIDE SITE | | | | | |
| 24 | Clear site for new roadworks & parking outside the site boundary | 1,650 | m2 | 3.00 | 4,950 |
| 25 | Bulk earthworks – minor cut to fill to achieve design levels – roadworks & parking outside site boundary | 500 | m3 | 18.00 | 9,000 |
| SITEWORKS – OUTSIDE SITE | | | | | |
| 13,950 | | | | | |
| ROADS, PAVING & DRAINAGE – WITHIN SITE | | | | | |
| 26 | New internal access roads – 30mm Asphalt on 200 thick roadbase | 7,400 | m2 | 120.00 | 888,000 |
| 27 | Mountable kerb or flush concrete edge beam | 1,950 | m | 90.00 | 175,500 |
| 28 | Soakwells within road system | | Item | | 30,000 |
| 29 | Pedestrian paving | 200 | m2 | 130.00 | 26,000 |
| ROADS, PAVING & DRAINAGE – WITHIN SITE | | | | | |
| 1,119,500 | | | | | |
| ROADS, PAVING & DRAINAGE – OUTSIDE SITE | | | | | |
| 30 | Extend existing sealed main access road including drop off zone bays, kerbing, drainage and earthworks – Second Avenue | 1,460 | m2 | 175.00 | 255,500 |
| 31 | Overflow parking – unsealed | 330 | m2 | 100.00 | 33,000 |
| 32 | Street lighting to road extension | | Item | | 60,000 |
| 33 | Raised Modwood (or similar) walkway and connect to existing including modifications to existing as necessary | 60 | m | 1,500.00 | 90,000 |
| ROADS, PAVING & DRAINAGE – OUTSIDE SITE | | | | | |
| 438,500 | | | | | |
| BUILDINGS & STRUCTURES – AMENITIES | | | | | |
| | <u>Transportable Modular Buildings including fabrication off-site, transport to site & install on site</u> | | | | |
| 34 | New Reception & Staff Laundry Building incorporating reception/waiting, general store, staff laundry, staffroom, staff WC, chemical store and kitchenette overall size 12000 x 3600 & 9600 x 3600 | 1 | No | 310,000 | 310,000 |
| 35 | Decking to reception/laundry building | 42 | m2 | 1,500.00 | 63,000 |
| 36 | Furniture & equipment to reception & staff laundry building | | Item | | 80,000 |
| 37 | New Amenities Building including ramps, decking & steps | 2 | No | 579,700 | 1,159,400 |
| 38 | Solar hot water systems – Amenities | 2 | Item | 30,000 | 60,000 |
| 39 | Fence to drying areas – Amenities | 20 | m | 400 | 8,000 |
| 40 | Pavement to drying enclosure | 40 | m2 | 200.00 | 8,000 |
| 41 | Screen to services enclosure | 22 | m | 500 | 11,000 |
| 42 | Clothes lines | 6 | No | 5,000 | 30,000 |
| 43 | BBQ Shelter, table, chairs, shade sails & BBQ's | 1 | No | 100,000 | 100,000 |
| 44 | Children's playground & equipment | | Item | | 50,000 |
| 45 | Bin enclosure | 1 | No | 20,000 | 20,000 |
| 46 | Fish cleaning station | 1 | No | 70,000 | 70,000 |

Cost Plan

Project: Ashburton

Details: OVCP Stage 3 (Phase 1) 17-01-2022

Building: Ocean View Caravan Park Onslow – Stage
3

| Code | Description | Quantity | Unit | Rate | Total |
|---|--|----------|------|-----------|-----------|
| BUILDINGS & STRUCTURES – AMENITIES | | | | | |
| 47 | Gas bullet hardstand | 1 | No | 10,000.00 | 10,000 |
| BUILDINGS & STRUCTURES – AMENITIES | | | | | |
| <i>(Continued)</i> | | | | | |
| CHALETS | | | | | |
| | <u>Transportable Modular Buildings including fabrication off-site, transport to site & install on site</u> | | | | |
| 48 | New chalet comprising ground level (12000 x 4200) & upper level (9600 x 4200) modules | 3 | No | 335,000 | 1,005,000 |
| 49 | Front deck to chalets 4200 x 2000 | 3 | No | 10,000.00 | 30,000 |
| 50 | Roof over front deck | 3 | No | 8,000.00 | 24,000 |
| 51 | Clothesline deck to chalets 4200 x 1050 | 3 | No | 8,000.00 | 24,000 |
| CHALETS | | | | | |
| 1,083,000 | | | | | |
| RV BAYS | | | | | |
| 52 | Road base hardstand (100 thick) | 9,055 | m2 | 40.00 | 362,200 |
| 53 | Annexe pad – 100 thick crushed rock pad with Astro Turf | 1,445 | m2 | 140.00 | 202,300 |
| 54 | 100 x 50 timber surround to annexe pad | 1,680 | m | 25.00 | 42,000 |
| RV BAYS | | | | | |
| 606,500 | | | | | |
| SERVICES – WITHIN SITE | | | | | |
| | Water | | | | |
| 55 | New pump | | Item | | 40,000 |
| 56 | Water tanks | | Item | | 60,000 |
| 57 | Water pipework reticulation within new caravan park site | | Item | | 44,000 |
| 58 | Connect to Kmac pillar | 39 | No | 250.00 | 9,750 |
| | Fire | | | | |
| 59 | Fire extinguisher & housing | 25 | No | 800.00 | 20,000 |
| | Sewer | | | | |
| 60 | Sewer pipework reticulation within new caravan park site | | Item | | 84,000 |
| 61 | Sullage dump point | | Item | | 10,000 |
| | Miscellaneous | | | | |
| 62 | Backflow prevention | | Item | | 4,000 |
| 63 | Testing & Commissioning | | Item | | 1,280 |
| | Electrical | | | | |
| 64 | Electrical services including access control & CCTV | | Item | | 400,000 |
| 65 | Allowance for bollard or similar lighting within caravan park areas | | Item | | 40,000 |
| | Builder's Work | | | | |
| 66 | Allowance for builder's works in connection with services works | | Item | | 7,970 |
| SERVICES – WITHIN SITE | | | | | |
| 721,000 | | | | | |

Cost Plan

Project: Ashburton

Details: OVCP Stage 3 (Phase 1) 17-01-2022

Building: Ocean View Caravan Park Onslow – Stage
3

| Code | Description | Quantity | Unit | Rate | Total |
|--------------------------------|--|----------|------|----------|-----------|
| SERVICES – OUTSIDE SITE | | | | | |
| 67 | Extend services (water, sewer & power) from Second Avenue to proposed new caravan park including locating and connecting to existing mains (assume common trench adjacent Second Ave.) | 200 | m | 510.00 | 102,000 |
| 68 | Allow for new transformer | | Item | | 100,000 |
| SERVICES – OUTSIDE SITE | | | | | |
| 202,000 | | | | | |
| MISCELLANEOUS | | | | | |
| 69 | Cable or boom gates | | Item | | 15,000 |
| 70 | New security fencing to perimeter of park | 750 | m | 350.00 | 262,500 |
| 71 | Single gate | 4 | No | 1,000.00 | 4,000 |
| 72 | Garrison fencing to overflow carpark | 70 | m | 600.00 | 42,000 |
| 73 | Double gate to last | 1 | No | 3,000.00 | 3,000 |
| 74 | Signage | | Item | | 10,000 |
| MISCELLANEOUS | | | | | |
| 336,500 | | | | | |
| PRELIMINARIES | | | | | |
| 75 | Preliminaries & General costs including but not limited to: | | Item | | 1,150,000 |
| 76 | Mobilisation | | | | |
| 77 | Fees, levees, insurances | | | | |
| 78 | Site facilities & running costs | | | | |
| 79 | Management plans | | | | |
| 80 | Supervision & management | | | | |
| 81 | Traffic management | | | | |
| 82 | Survey | | | | |
| 83 | Consumables | | | | |
| 84 | Demobilisation | | | | |
| 85 | Contractor margin | | | | |
| PRELIMINARIES | | | | | |
| 1,150,000 | | | | | |